

March 27, 2020

TO: All Bidders

PROJECT: SINGLE POINT ENTRY – 4 SITES

ANDERSON, HARMON, KENDALL AND WILSON

RE: ADDENDUM 1

This addendum forms a part of the contract documents for the above-named project and modifies the original drawings and project manual provided in the subject Bid. All portions of the contract documents not specifically modified in this Addendum remain in full force and effect.

Careful note of the Addendum shall be taken by all parties of interest so that the proper allowances may be made in strict accordance with the Addendum, and that all trades shall be fully advised in the performance of the work which will be required of them.

Bidder shall acknowledge receipt of this Addendum in the space provided on the Bid Form. Failure to do so may subject Bidder to disqualification.

PROJECT MANUAL

- 1.1 Section 05 50 00 METAL FABRICATIONS
 - **1.1.1** 1.01 SECTION INCLUDES:
 - **1.1.1.1** ADD C: Tube Steel posts for support of low walls.
 - **1.1.1.2** ADD D: Steel angle bracing for interior partitions.
- 1.2 Section 08 71 00 DOOR HARDWARE
 - 1.2.1 2.01 DESIGN AND PERFORMANCE CRITERIA:
 - **1.2.1.1** ADD 2.01 G: All exit devices shall be Sargent 3828F Series, no substitutions allowed.
 - 1.2.1.2 ADD 2.01 H: All passage sets, privacy sets and cylindrical lock sets shall be Marks -SURVIVOR 195 Series, no substitutions allowed.
- 1.3 Section 09 65 00 RESILIENT FLOORING
 - **1.3.1** At 2.02 Tile Flooring
 - 1.3.1.1 Add line 9 as follows; LVT Basis of Design Material shall be Mohawk Hot and Heavy METAL, colors as selected by architect.
- 1.4 Section 09 68 13 TILE CARPETING
 - 1.4.1 At 2.03 Materials
 - 1.4.1.1 Add line 14 as follows; Basis of Design carpet shall be Mohawk Learn and Live Collection Rise Up, Side Stripe and Swipe Right, colors as selected by architect.

March 27, 2020
Single Point Entry — 4 Sites
Anderson, Harmon, Kendall And Wilson
ADDENDUM 1
Page 2 of 2

DRAWINGS

ANDERSON ES

- 1.5 Replace Sheet AS1.2 ENLARGED SITE PLAN with the sheet contained within this addendum.
- 1.6 Replace Sheet A-1.0 FLOOR PLAN with the sheet contained within this addendum.
- 1.7 Replace Sheet A-9.0 STOREFRONT DETAILS with the sheet contained within this addendum.
- 1.8 Replace Sheet E-2 ELECTRICAL FLOOR PLAN with the sheet contained within this addendum.

HARMON ES

- 1.9 Replace Sheet AS1.1 NEW SITE PLAN with the sheet contained within this addendum.
- 1.10 Replace Sheet A-1.0 FLOOR PLAN/ENLARGED INTERIOR ELEVATION with the sheet contained within this addendum.

KENDALL ES

- 1.11 Replace Sheet AS1.2 PROPOSED SITE PARKING with the sheet contained within this addendum.
- 1.12 Sheet A-1.0 FLOOR PLAN: Add the following note: "In addition to painting already indicated Paint walls of Room 103 Storage and Ceiling of Restroom 112 and al interior doors and frames".
- 1.13 Sheet A-2.0 DETAILS
 - 1.13.1 DETAIL 21 METAL STUD WALL
 - 1.13.1.1 Clarification: Provide 4 (4) 12' long min. C4x4.5 channels, welded to existing steel structure above for support of interior partitions, exact configuration to be determined by field conditions. Remove and replace ceiling tile as required for access.
- 1.14 Replace Sheet E-2 ELECTRICAL FLOOR PLAN with the sheet contained within this addendum.

WILSON ES


- 1.15 Replace Sheet AS1.1 ENLARGED SITE PLAN with the sheet contained within this addendum.
- 1.16 Sheet A-1.1 FLOOR PLAN:
 - 1.16.1 Add the following note: "Paint all new walls and any walls disturbed during construction.
 - 1.16.2 Add the following note: "Protect in place existing VCT flooring in the Multi Use space 108".

Sincerely,

Brian Gridley

Brian Gridley, Architect

Project Architect

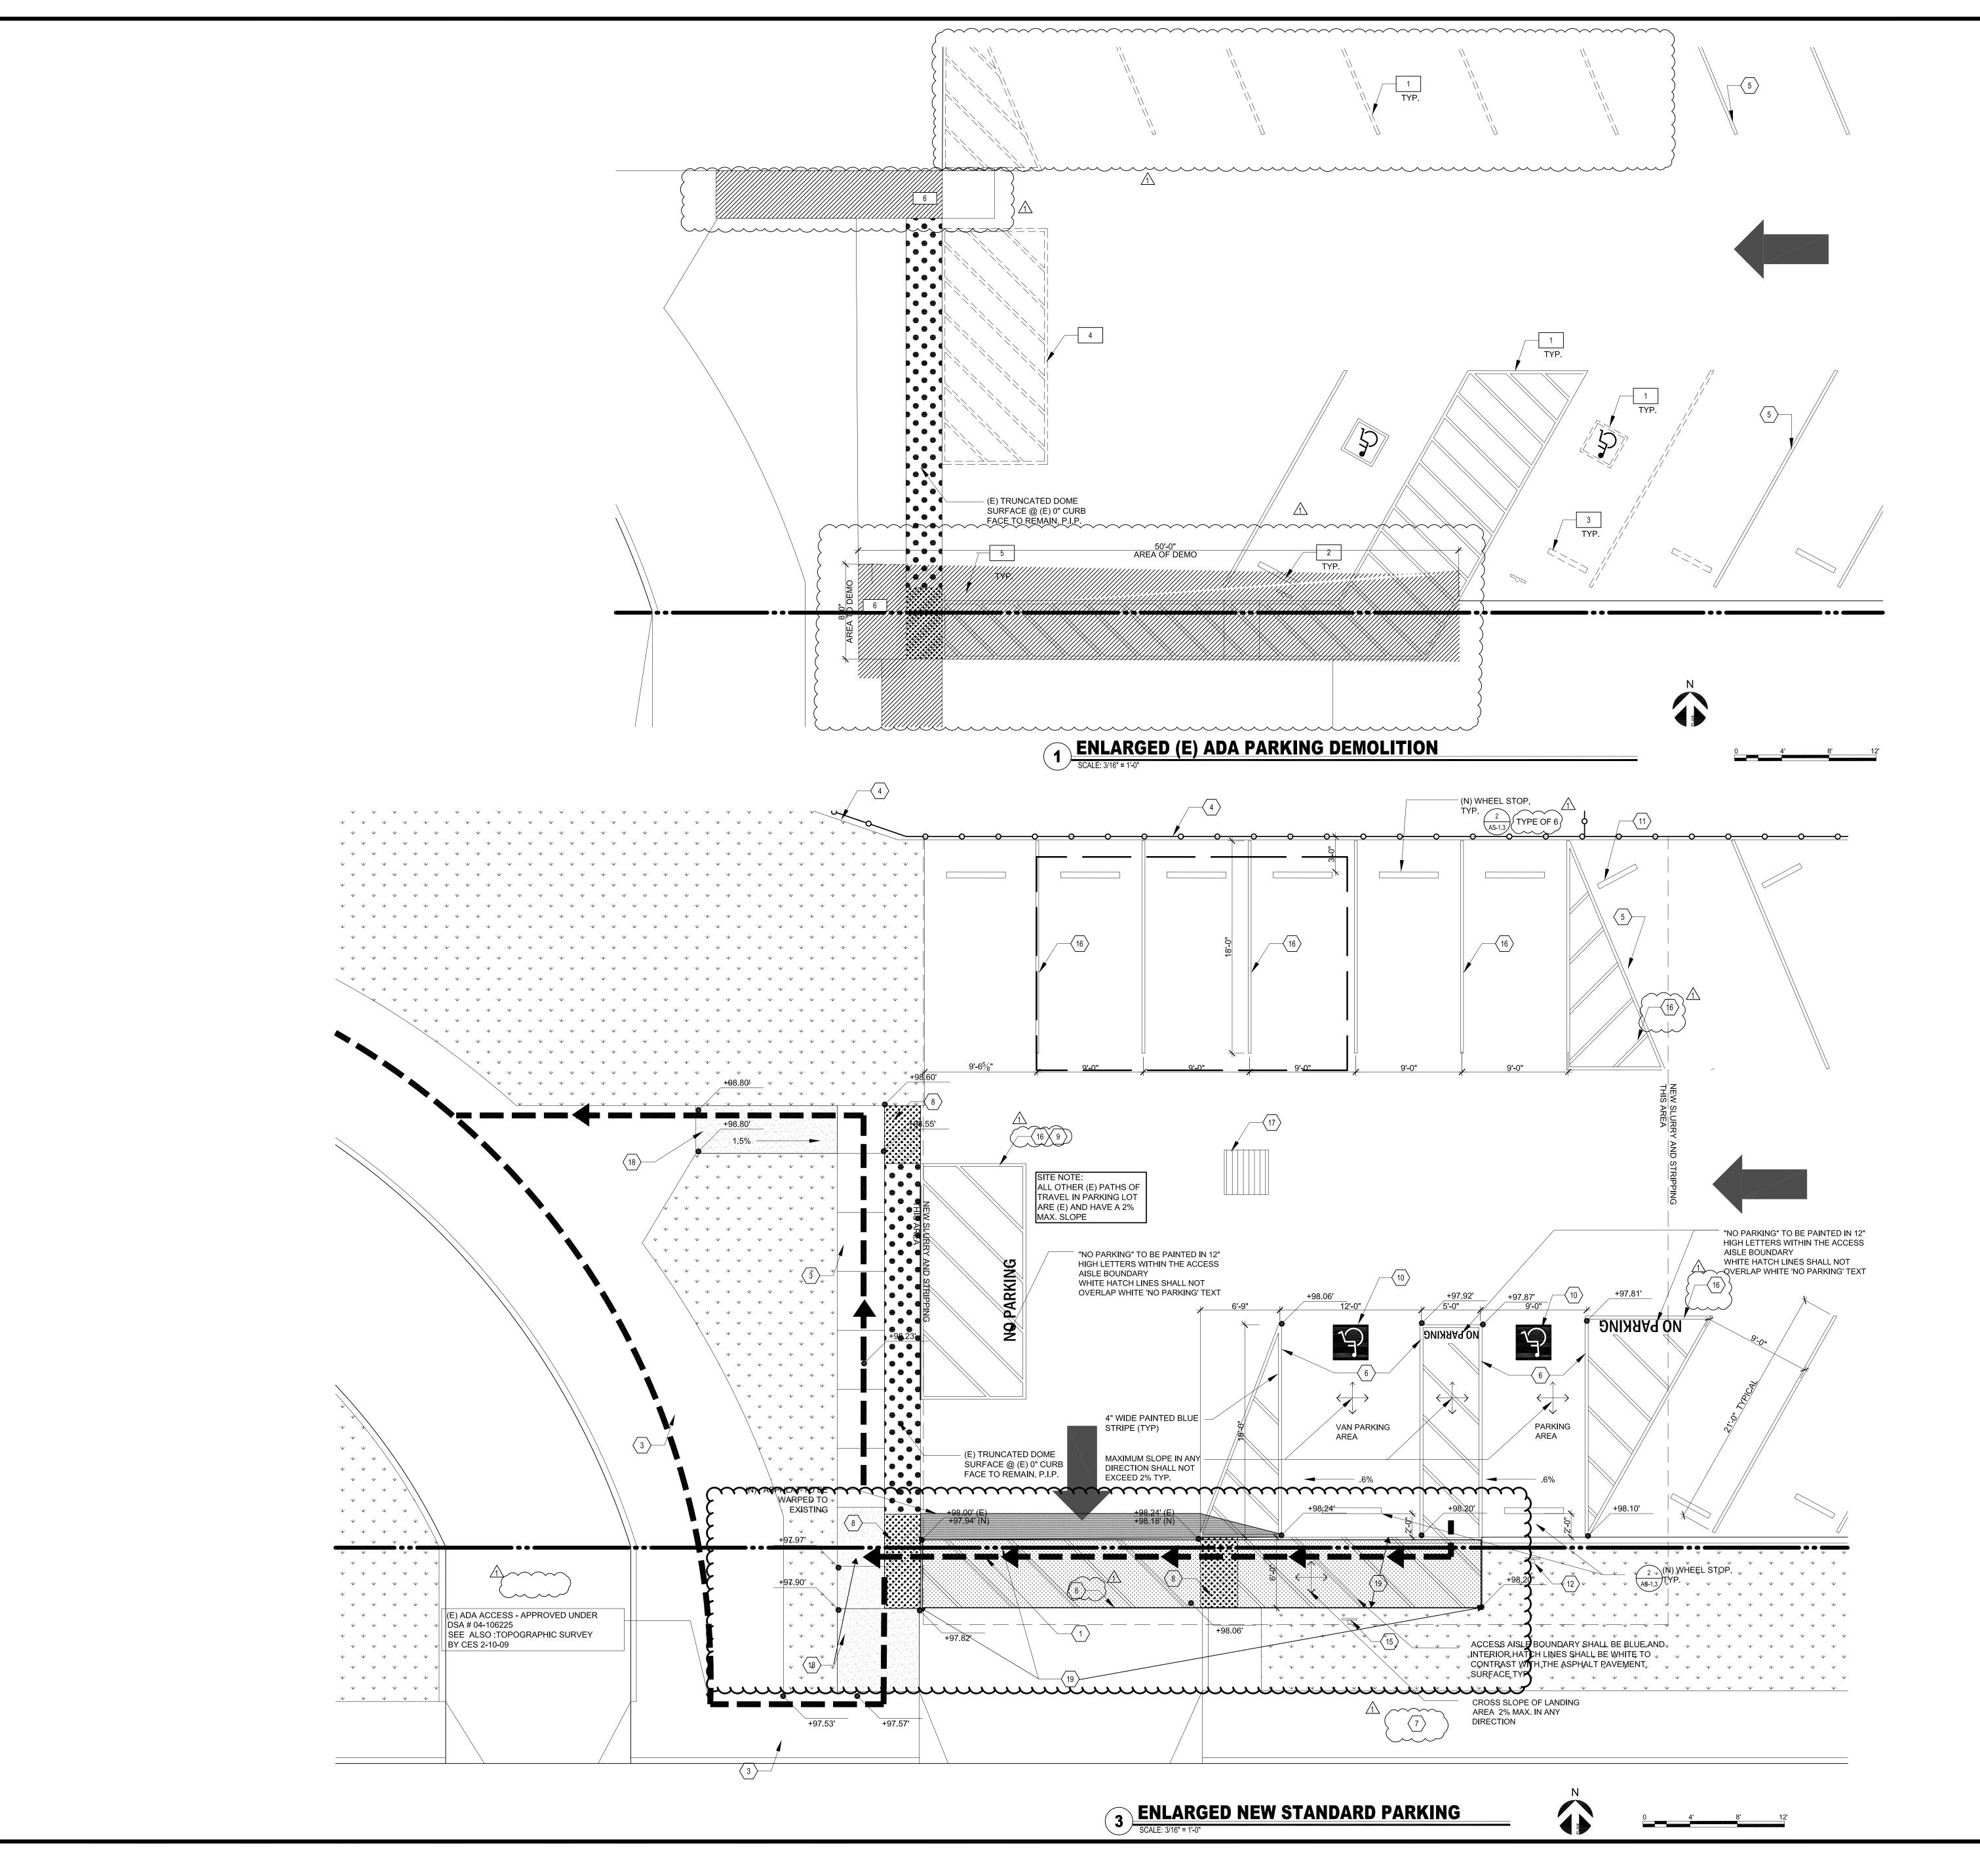

SITE PLAN KEYNOTES

- (N) P.O.T. TO ADMINISTRATION BUILDING WITH (N) INTERIOR ENTRY POINT LOCATIONS
- NOT USED

 3 (E) CONCRETE WALKWAY TO REMAIN; PROTECT IN PLACE
- (E) CHAIN-LINK FENCE/GATES TO REMAIN; PROTECT IN PLACE
- (E) REGULAR PARKING LOT STRIPING TO REMAIN; PROTECT IN PLACE; CONTRACTOR TO RE-STRIPE ANY STALLS THAT
- ARE DAMAGED IN CONSTRUCTION

 (N) SPACES W/ ADA BLUE STRIPING AT ACCESSIBLE SPACES;
 TYPICAL
- (E) CONCRETE PUBLIC SIDEWALK (AND CURB & GUTTER)
- $\begin{array}{c} 7 \\ \text{WHERE OCCURS)} \end{array} \text{ TO REMAIN; PROTECT IN PLACE} \\ \hline \left(8\right) \\ \text{(N) TRUNCATED DOMES SEE DTL} \\ \hline \left(\frac{3}{\text{AS-1.3}}\right) \\ \end{array}$
- 9 (N) DROP-OFF STRIPING AT (E) DROP-OFF AREA
- (N) ADA SYMBOL; SEE DTL $\begin{pmatrix} 1 \\ AS-1.3 \end{pmatrix}$
- (E) WHEEL STOPS TO REMAIN
- (N) ADA PARKING SIGN WITH MIN. \$250 TEXT SEE DTL. $\frac{7}{\text{AS-1.3}}$
- $\left\langle \begin{array}{c} 13 \end{array} \right\rangle$ NOT USED $\left\langle \begin{array}{c} 1 \end{array} \right\rangle$
- (N) PARKING STRIPING FOR CONVERSION TO REGULAR STALLS
- (N) ADA VAN ACCESSIBLE PARKING SIGN WITH MIN. \$250 TEXT SEE DTL. (AS-1.3)
- SIGN WITH MIN. \$250 TEXT SEE DTL. (N) PARKING STRIPPING
- (E) DRAIN AND GRATE TO REMAIN AND PROTECT IN PLACE
- (N) CONCRETE SIDEWALK
- (N) 6" THICK CONCRETE WITH #4 REBAR AT 16" O.C. EACH WAY LIGHT BROOM FINISH

DEMOLITION NOTES

- 1 DEMOLITION DIAGONAL ADA PARKING STRIPPING
- 2 DEMOLITION (E) ADA PARKING SIGNAGE
- 3 RELOCATE (E) ADA PARKING WHEEL STOP AS NEEDED
- 4 DEMOLITION DROP-OFF PARKING STRIPPING
- 5 DEMOLITION AND EXCAVATION OF ASPHALT
- 6 DEMOLITION AND EXCAVATION OF CONCRETE

SITE PLAN NOTES

- 1. PARKING LOT SHALL RECEIVE (N) PARKING STRIPING FOR (N) ADA STALLS/P.O.T. AND (N) REGULAR STALLS THAT REPLACED THE (E) ADA STALLS.
- 2. TRUNCATED DOME DETECTABLE WARNING SURFACE IS REQUIRED ON CURB RAMPS PER 2016 CBC SEC. 11B-406.5.12 & 11B-705.1.2.2, CHANGE IN ELEVATION GREATER THAN 6" REQUIRES HANDRAILS. RAMP SLOPE NOT TO EXCEED 8.33% AND FLARED SIDES NOT TO EXCEED 10%



APPLICANT:



SAN BERNARDINO CITY UNIFIED SCHOOL

BOARD OF EDUCATION
BUILDING
777 NORTH F STREET
SAN BERNARDINO, CA

92410 (909) 381-1100

PROJECT:




ANDERSON ELEMENTARY SCHOOL

24302 4TH STREET SAN BERNARDINO, CA 92410

(909) 388-6311

ENLARGED SITE

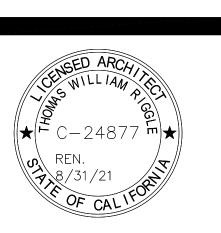

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EV. REVISION IO. DESCRIPTION DATE B

SITE PLAN LEGENDS



PATH OF TRAVEL

NOTE:
ACCESSIBLE PATH OF TRAVEL AS INDICATED ON PLAN IS A
BARRIER-FREE ACCESS ROUTE WITHOUT ANY ABRUPT LEVEL
CHANGES EXCEEDING 1/2" IF BEVELED AT 1:2 MAX. SLOPE, OR
VERTICAL LEVEL CHANGES NOT EXCEEDING 1/4" MAX., AND
AT LEAST 48" IN WIDTH. SURFACE IS STABLE, FIRM AND SLIP
RESISTANT. CROSS SLOPE DOES NOT EXCEED 2% AND
SLOPE IN THE DIRECTION OF TRAVEL IS LESS THAN 5%,
UNLESS OTHERWISE INDICATED. ACCESSIBLE PATH OF
TRAVEL SHALL BE MAINTAINED FREE OF OVERHANGING
OBSTRUCTIONS TO 80" MINIMUM, AND PROTRUDING OBJECTS
GREATER THAN 4" PROJECTION FROM WALL AND ABOVE 27"
AND LESS THAN 80". ARCHITECT SHALL VERIFY THAT THERE

ARE NO BARRIERS IN THE PATH OF TRAVEL.

PRINTED: 3/27/2020

ADDENDUM #1

DRAWN: JM


JOB #: 18-059

DATE: 3/27/20

SCALE: AS NOTED

SHEET NO:

AS-1.2

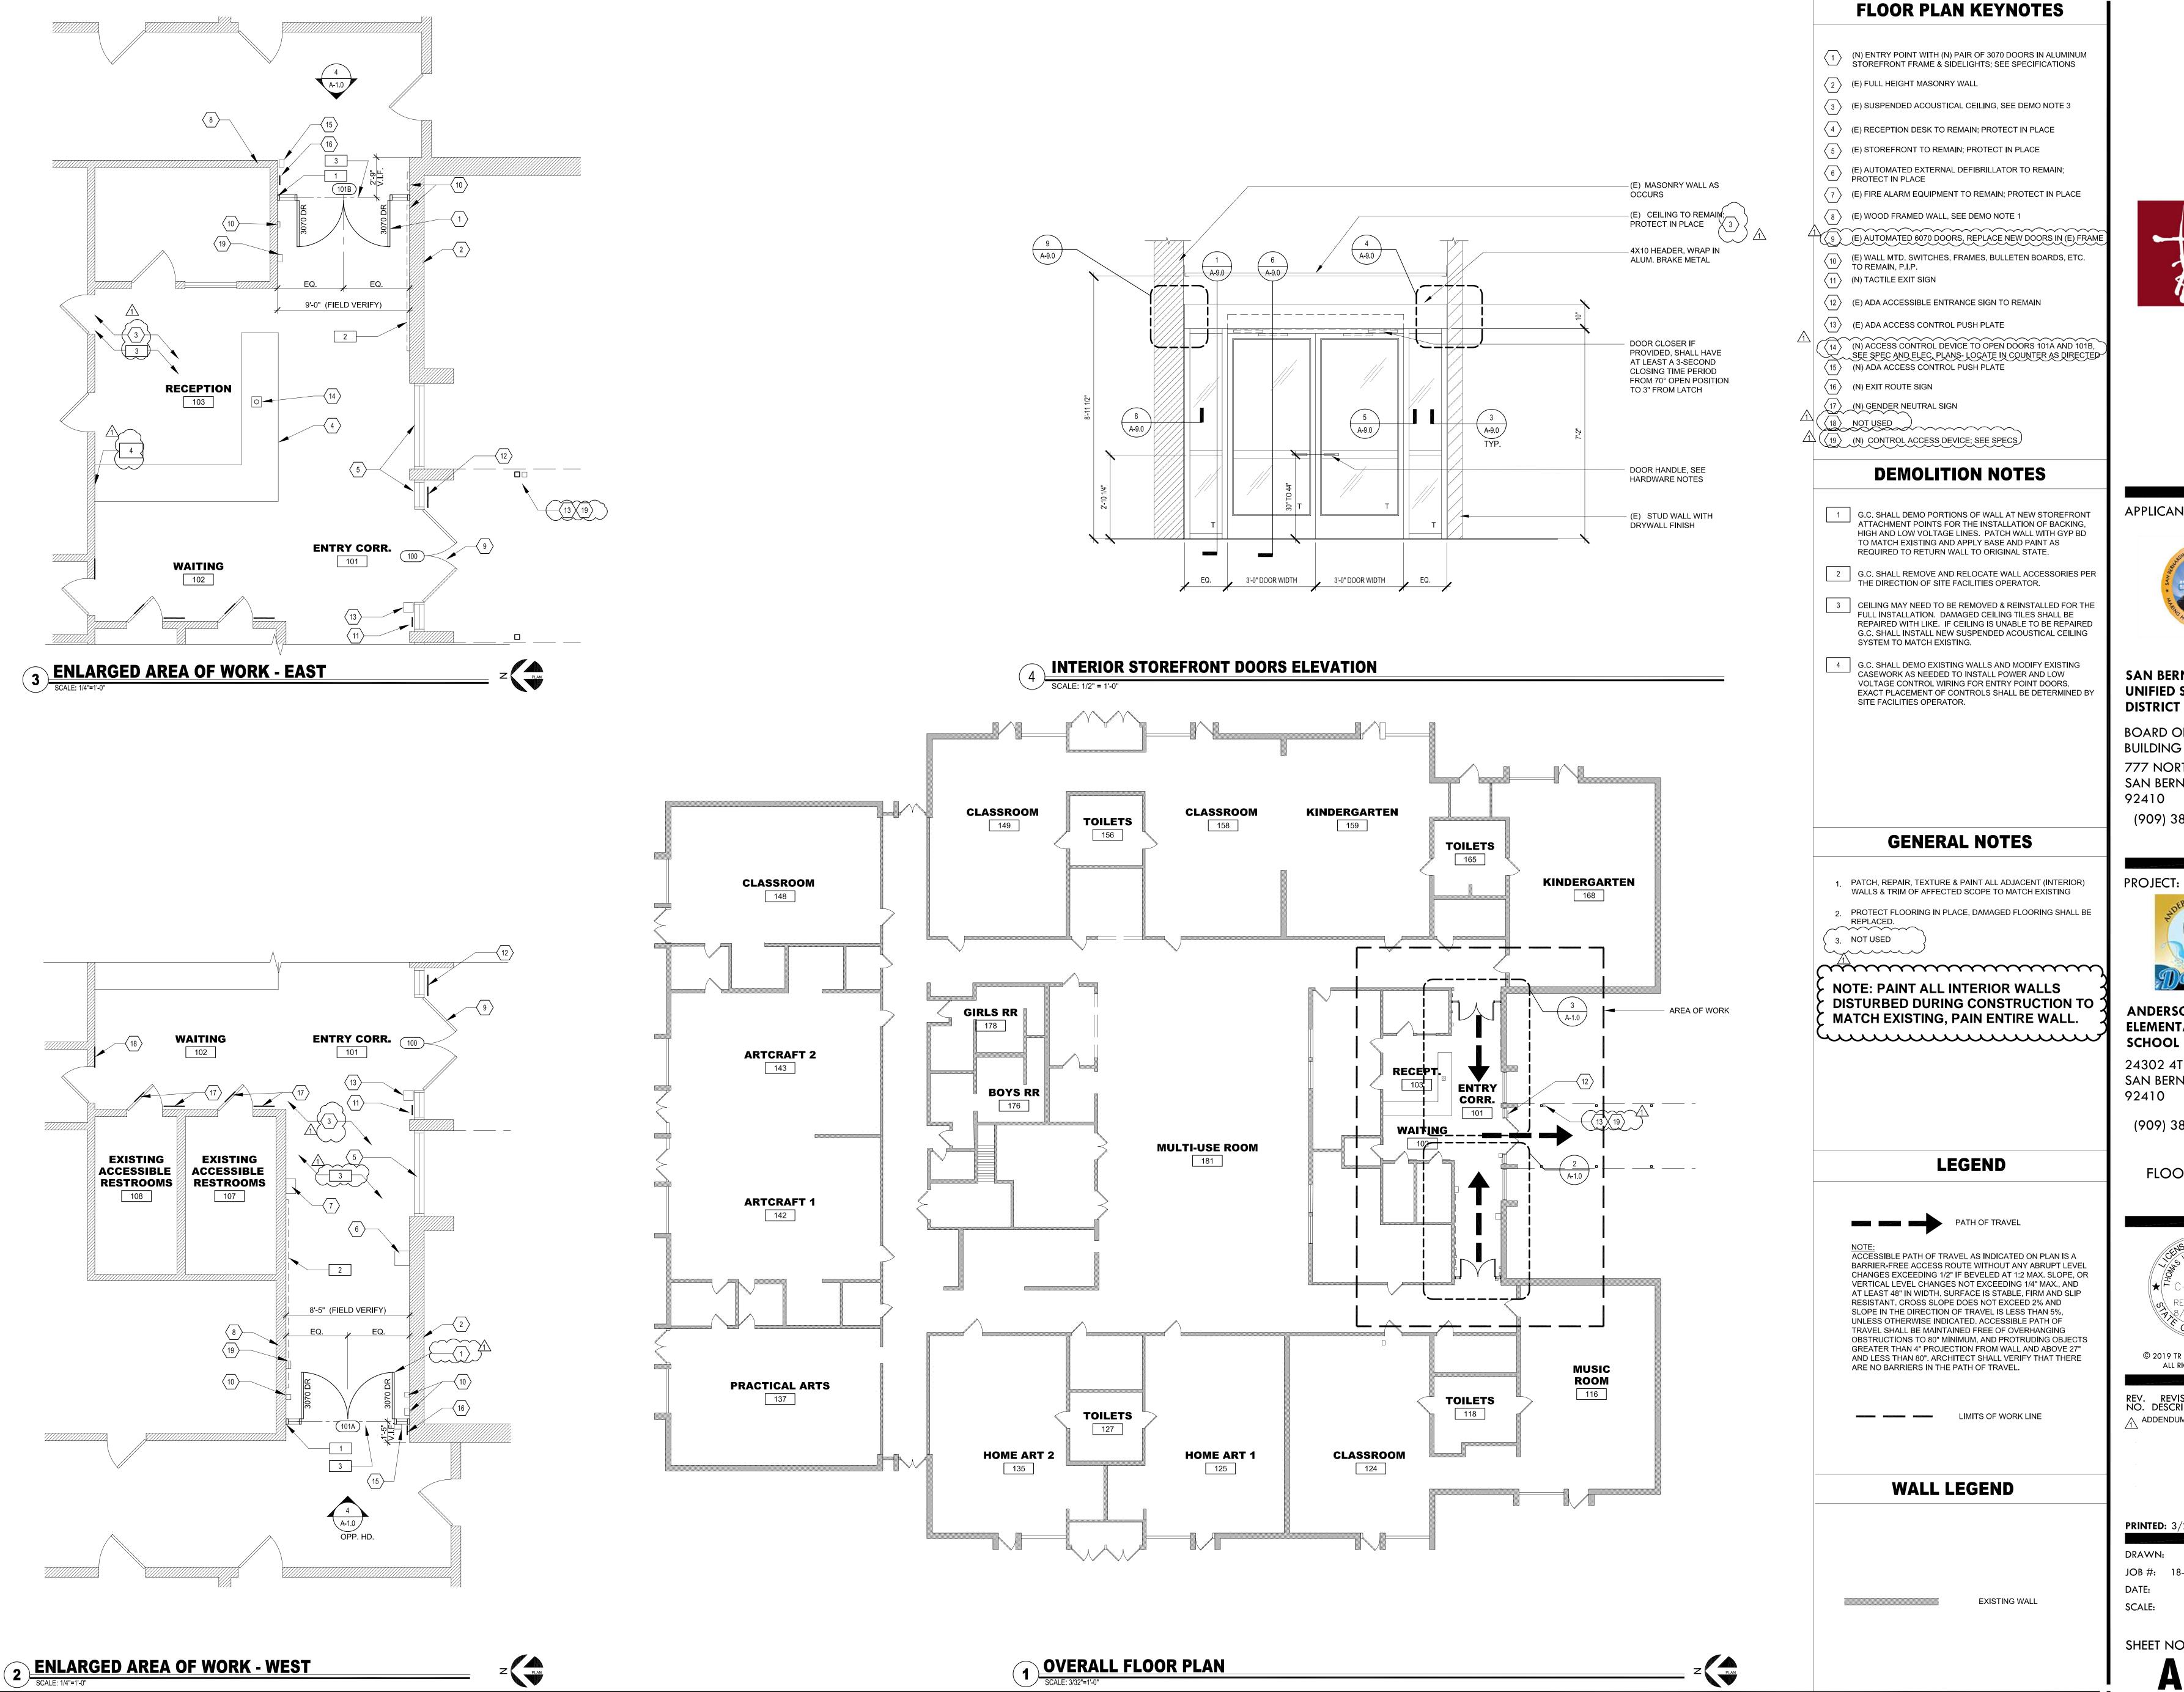

APPLICANT:



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FLOOR PLAN



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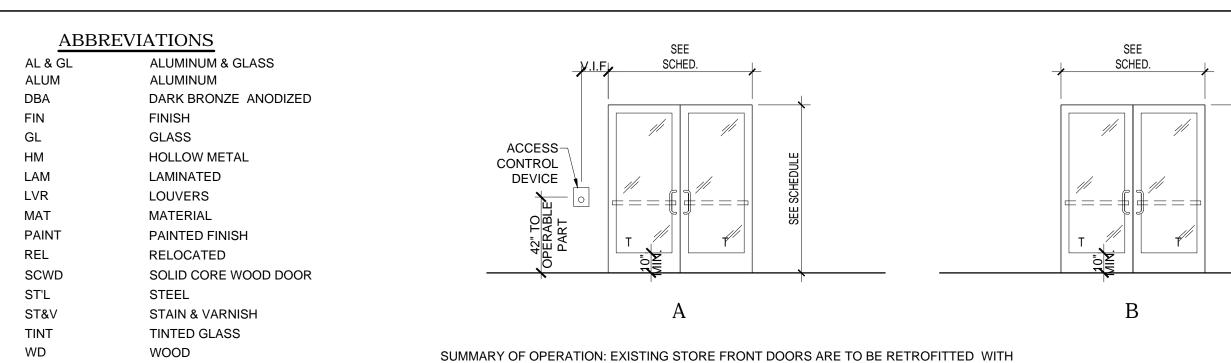
REV. REVISION NO. DESCRIPTION DATE BY ∴ ADDENDUM #1 03/27/2020

PRINTED: 3/27/2020

DRAWN: ----



DOOR TYPES



TEMPERED SAFETY GLASS

 \sim

US26D

VON

SUMMARY OF OPERATION: NEW STOREFRONT DOORS AND EXIST FRAME TO BE FITTED WITH

ELECTRIFIED PANIC HARDWARE TO ALLOW FOR ENTRY VIA AIPHONE SYSTEM (ACCESS GRANTED

MODEL 547

AFTER REVIEW BY STAFF OR BY KEY. EXIT VIA ACCESSIBLE ASSIST DOOR BUTTON ACTIVATION OR

HARDWARE SETS

1 EA ELECTRIFIED HINGE MODEL E-M19

PANIC HARDWARE EL-PA 99-27-NLOP-LBR-3'

HW SET:1

2 EA

2 SET

1 EA

1 EA

2 EA

1 EA

1 EA

2 EA

1 EA

2 EA

2 EA


VIA PANIC HARDWARE.

HINGE

DOOR NOTES

1. EMERGENCY EXIT AND PANIC HARDWARE SHALL COMPLY
WITH SFM STANDARD 12-10-3, SECTION 12-10-302.
(A) THE CROSS-BAR SHALL EXTEND ACROSS NOT LESS THAN ONE-HALF
THE WIDTH OF THE DOOR/GATE.

2. DOOR LEVERS, HANDLES AND EXIT DEVICES SHALL BE MOUNTED AT 34" - 44" A.F.F. AND COMPLY WITH CBC 11B-309.4

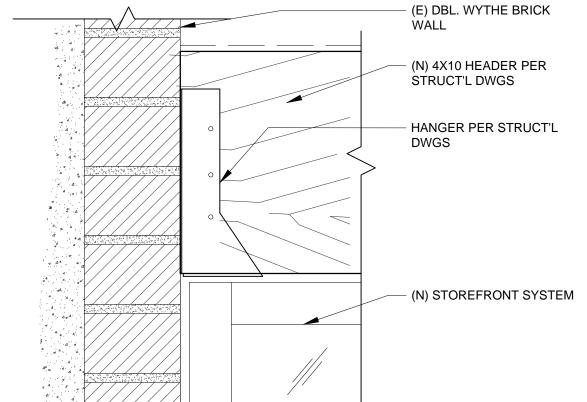

(N) DOOR, SEE SCHEDULE

- (E) CONC. CURB TO BE

- (N) S.S. 226 SLEEVE

ANCHOR 1/4"X3"

DEMO'D AT (N) OPENING

(N) OFFSET THRESHOLD


- (N) CONC. LANDING W/ 2%

HEADER TO MASONRY WALL SCALE: 3" = 1'-0"


DOOR THRESHOLD DETAIL

FOUNDATION / SLAB

SCALE: 3" = 1'-0"

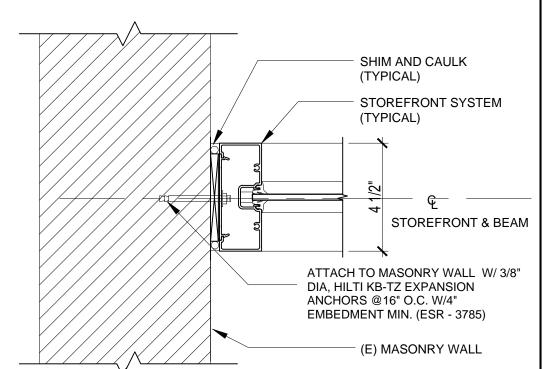

S.F. JAMB TO MASONRY WALL SCALE: 3" = 1'-0"

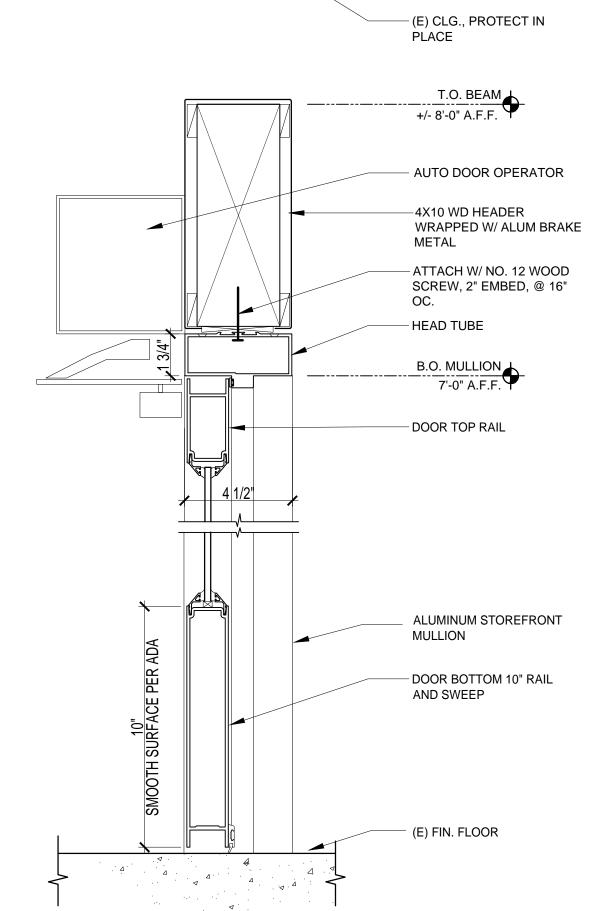


INT. STOREFRONT DOOR SECTION

SCALE: 3" = 1'-0"

ALUM. DOOR w/ TEMPERED GLAZING, SEE SCHEDULE ALUM. DOOR FRAME, U.N.O.


DOOR JAMB TO STOREFRONT

SCALE: 3" = 1'-0"

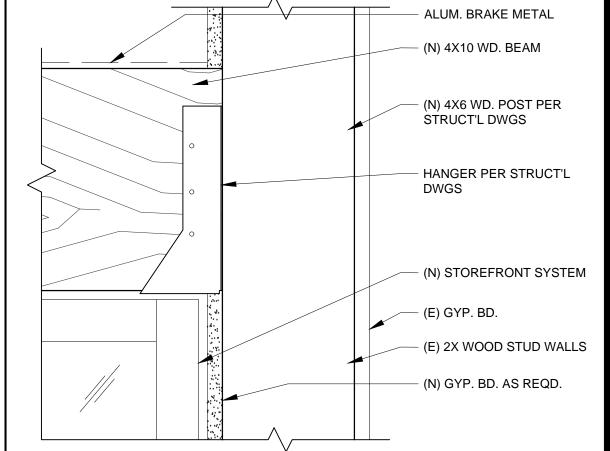


BEAM TO STUD WALL

SCALE: 3" = 1'-0"

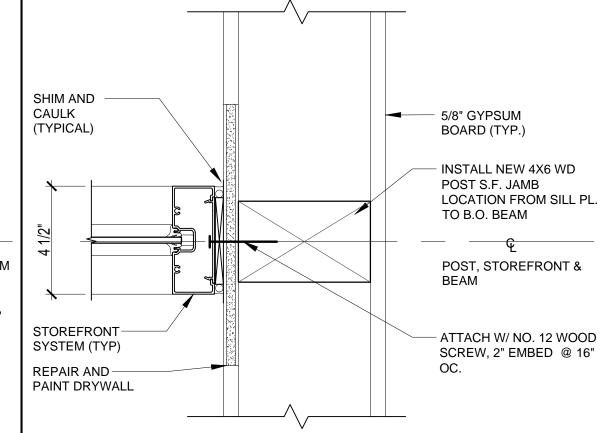

S.F. JAMB TO STUD WALL

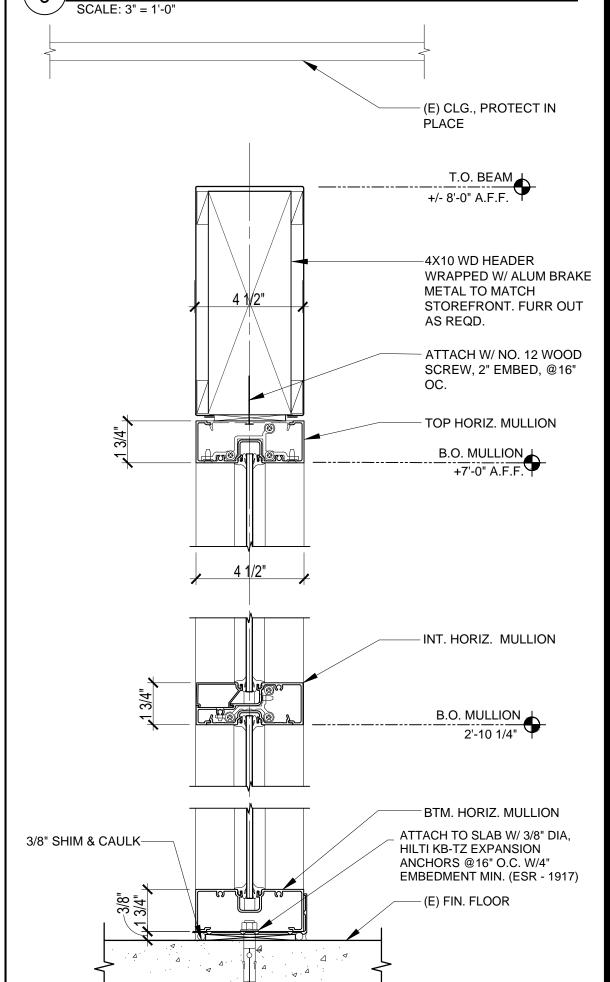

INTERIOR STOREFRONT SECTION

SCALE: 3" = 1'-0"





APPLICANT:




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STOREFRONT **DETAILS**





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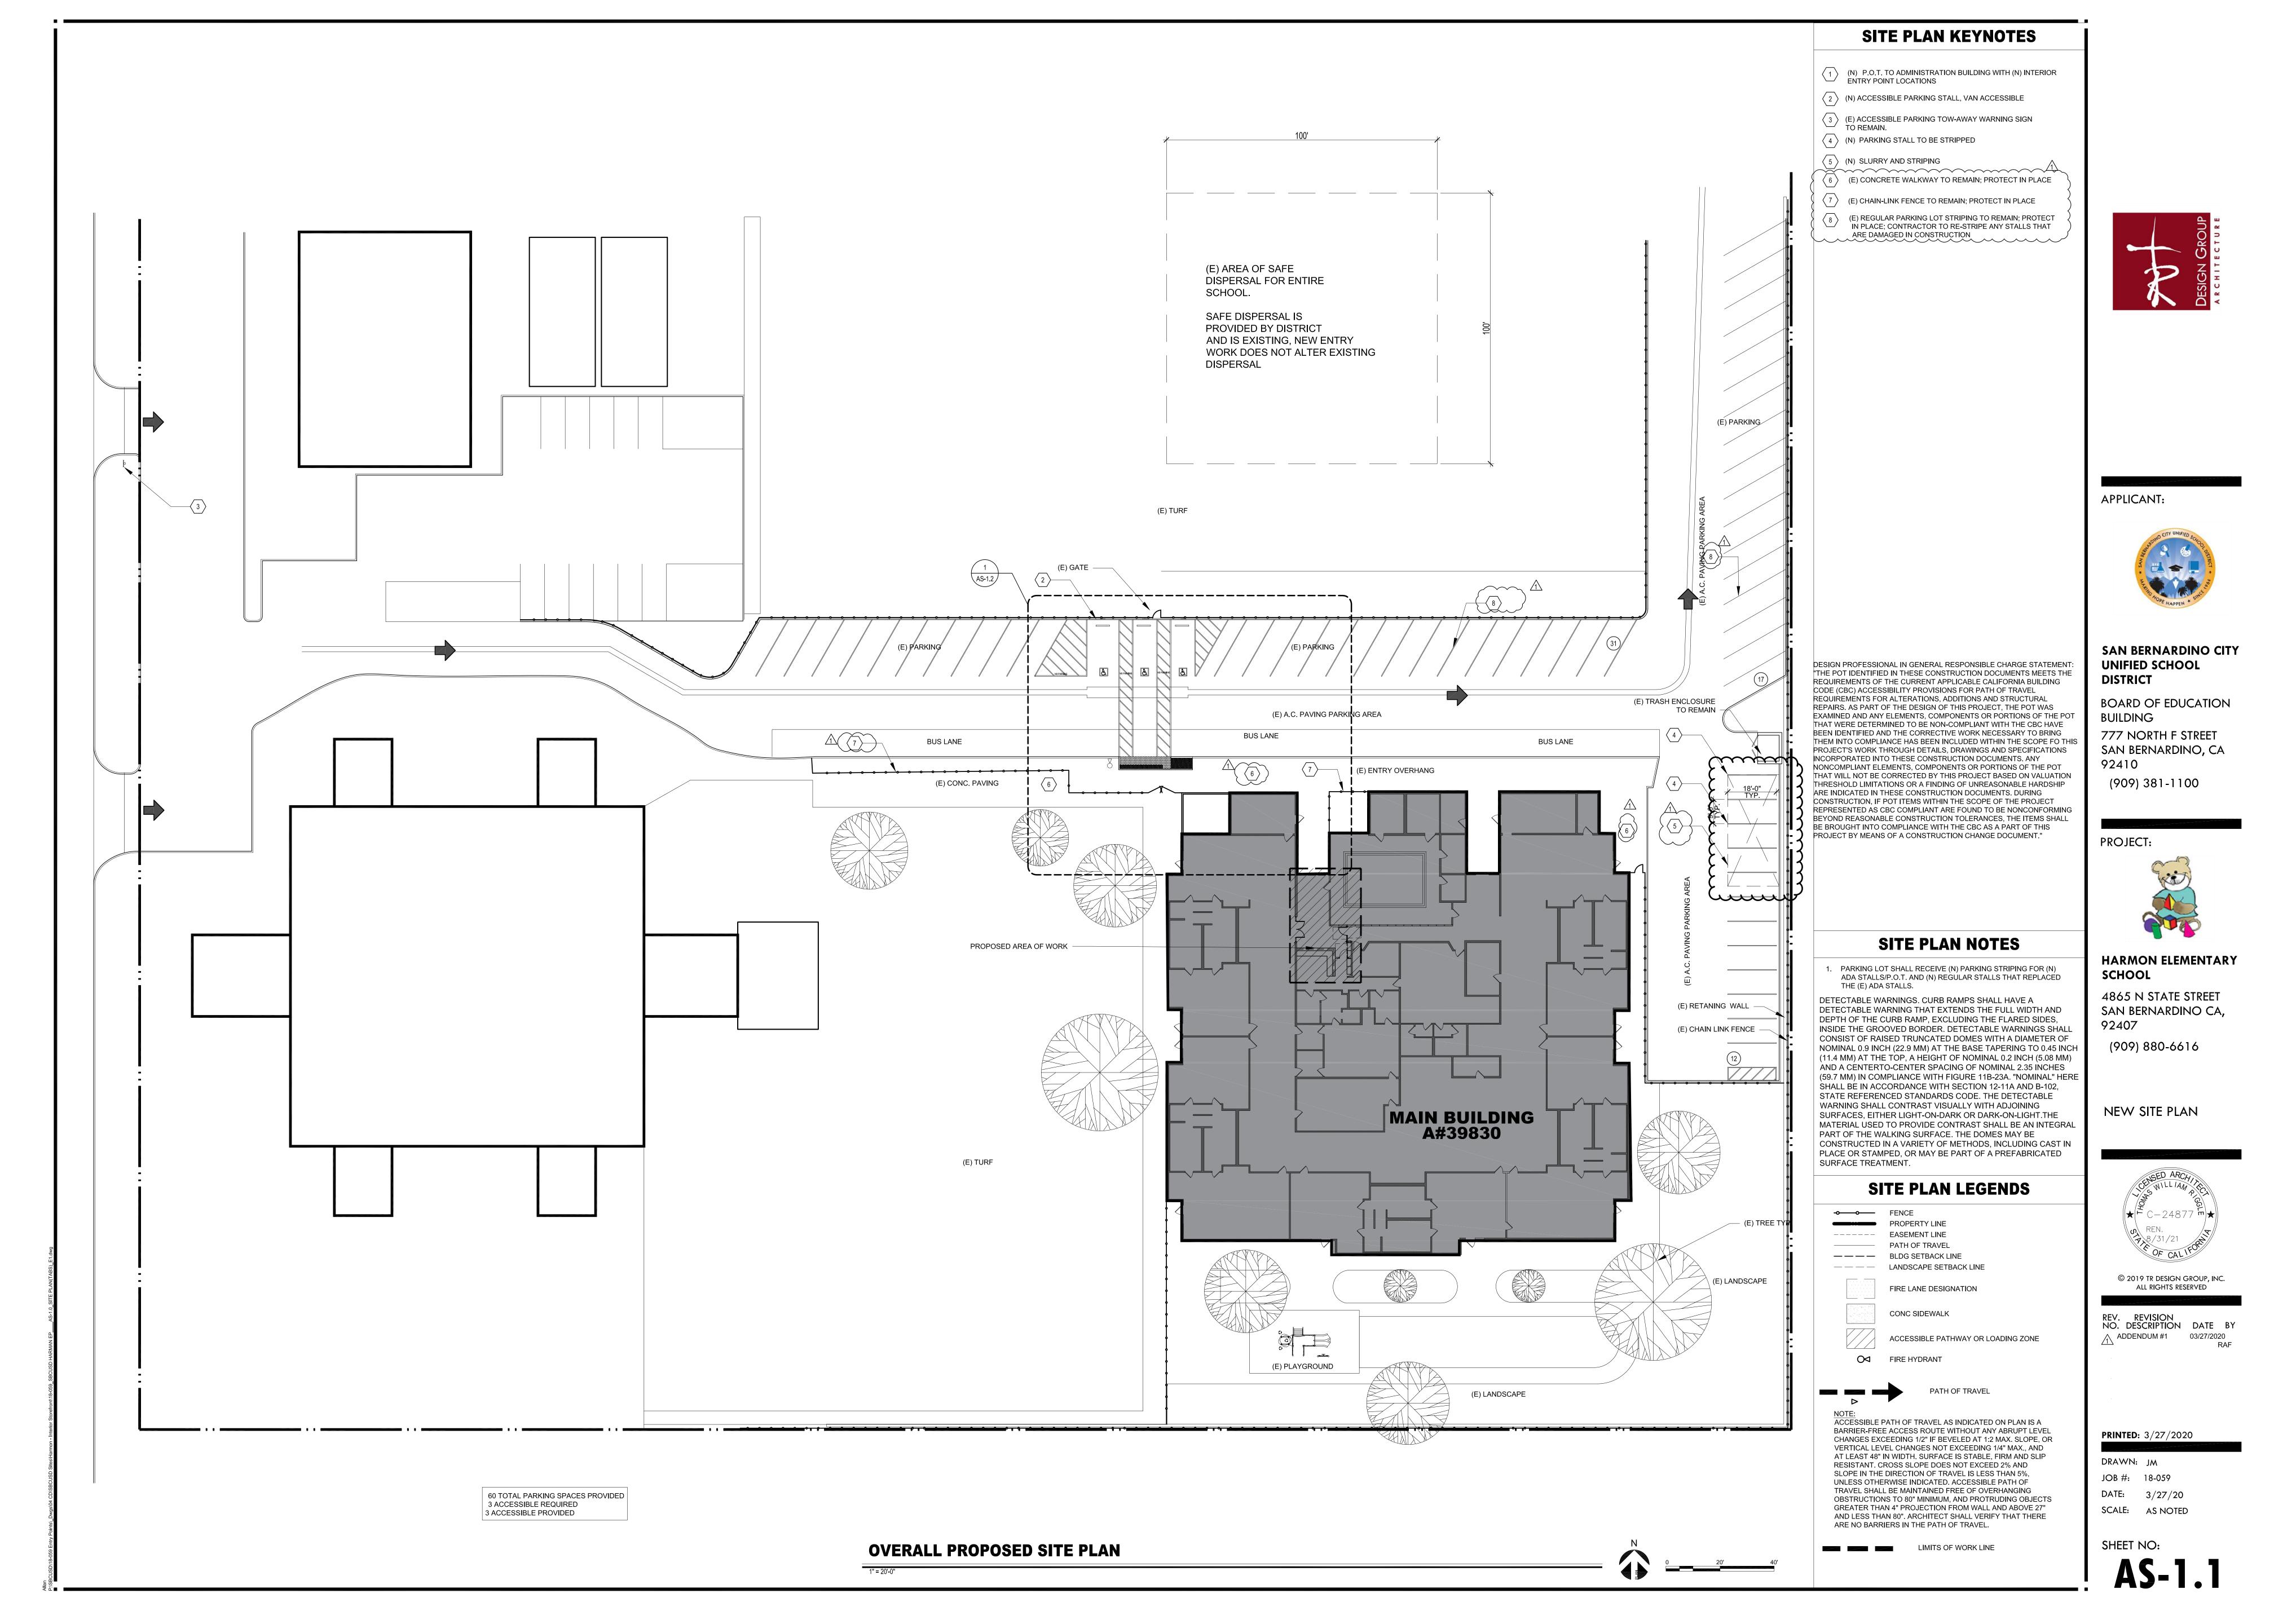
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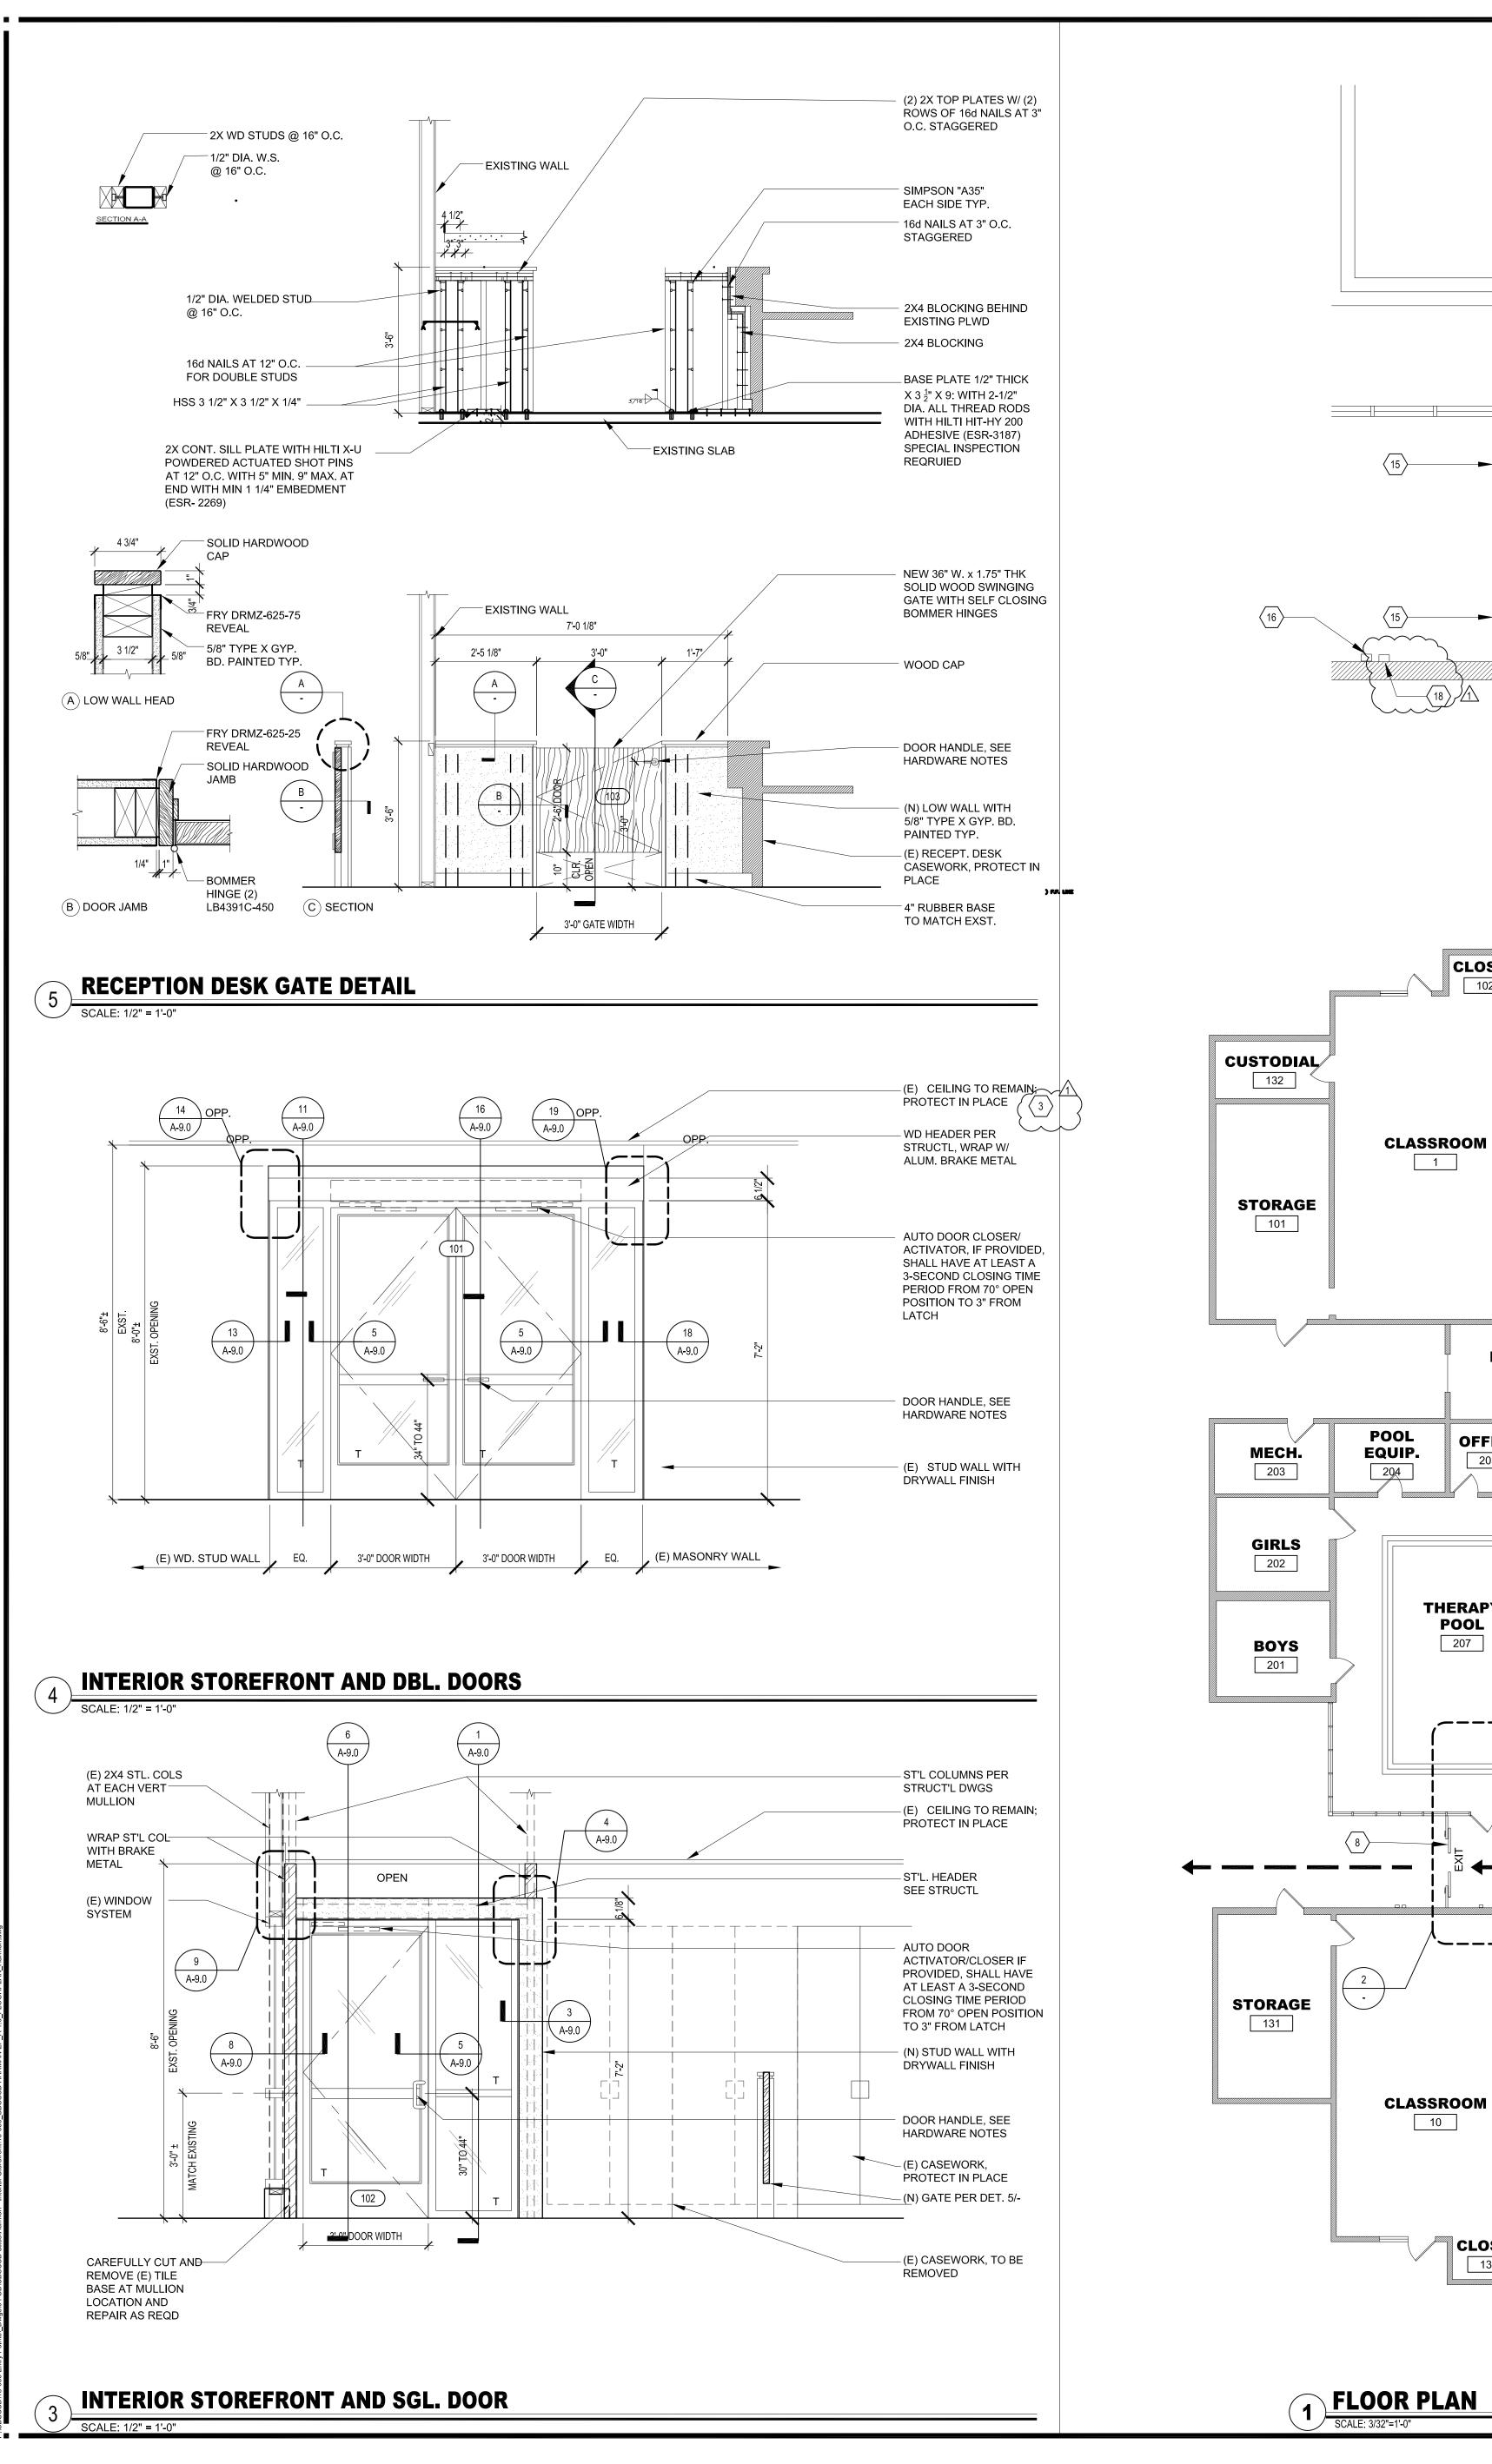
DRAWN: RJ JOB #: 18-059 DATE: 9/16/19 **SCALE** SCALE:




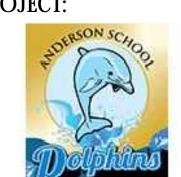




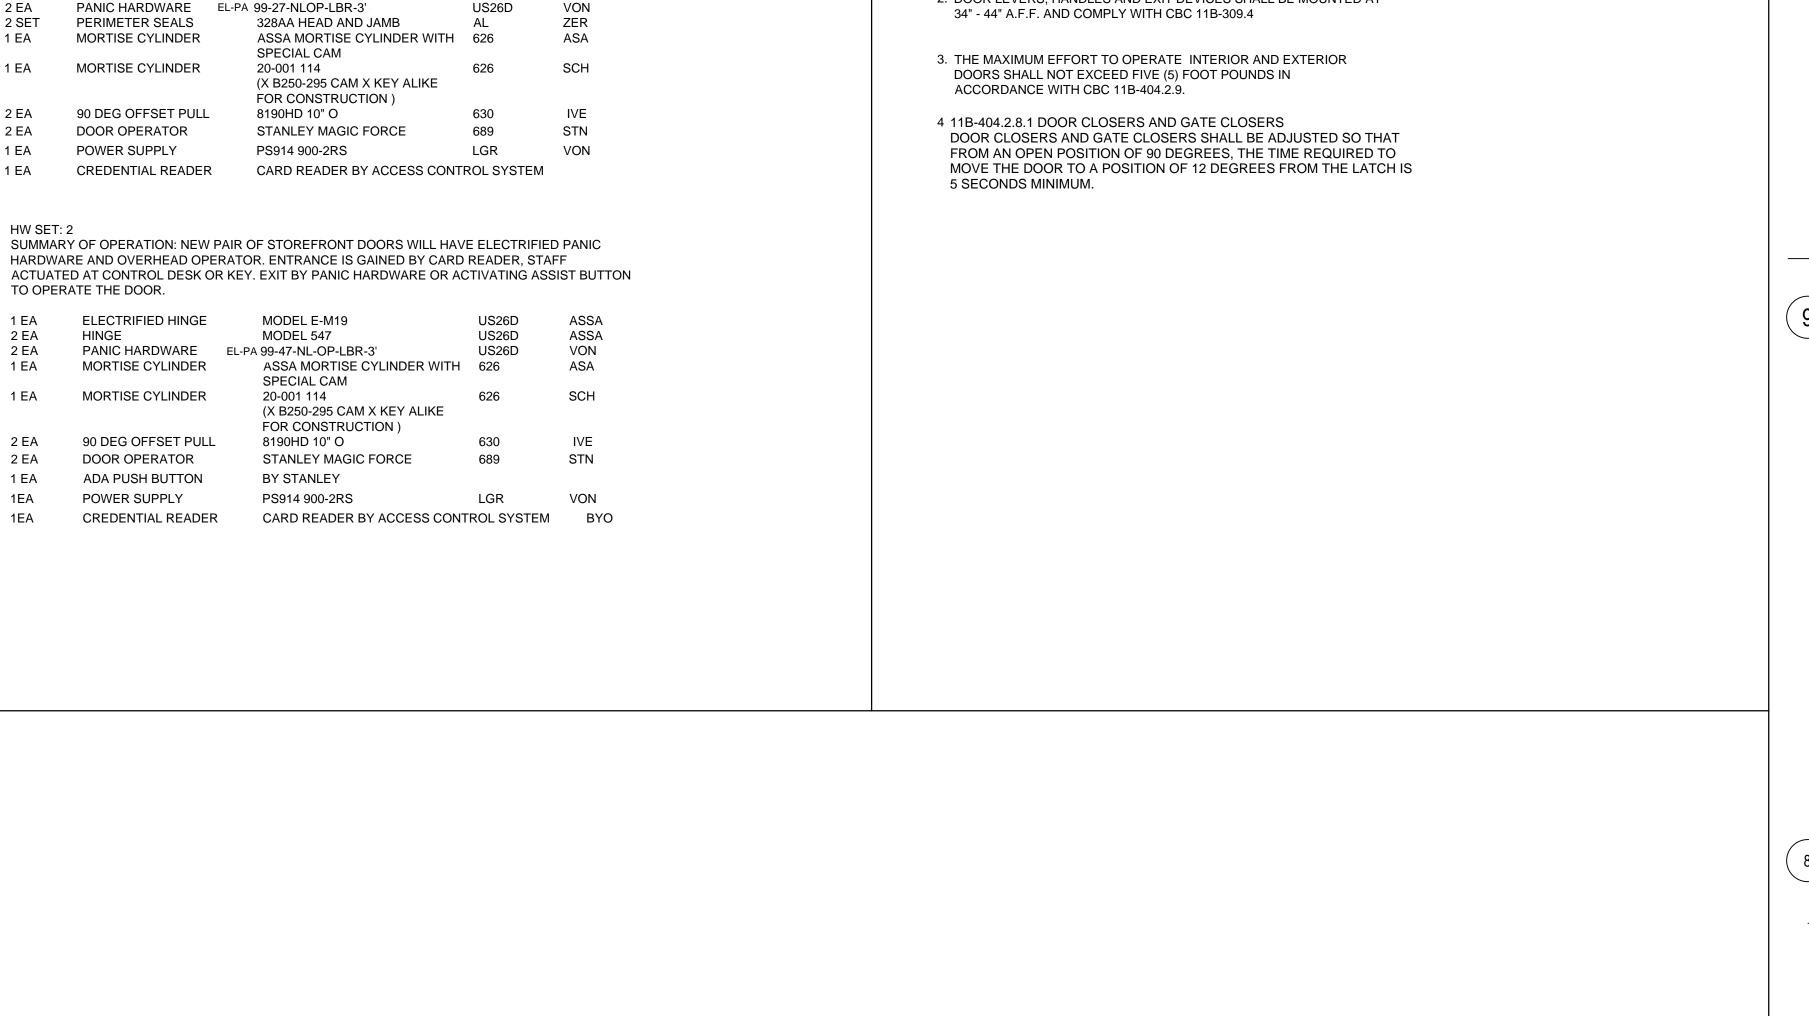

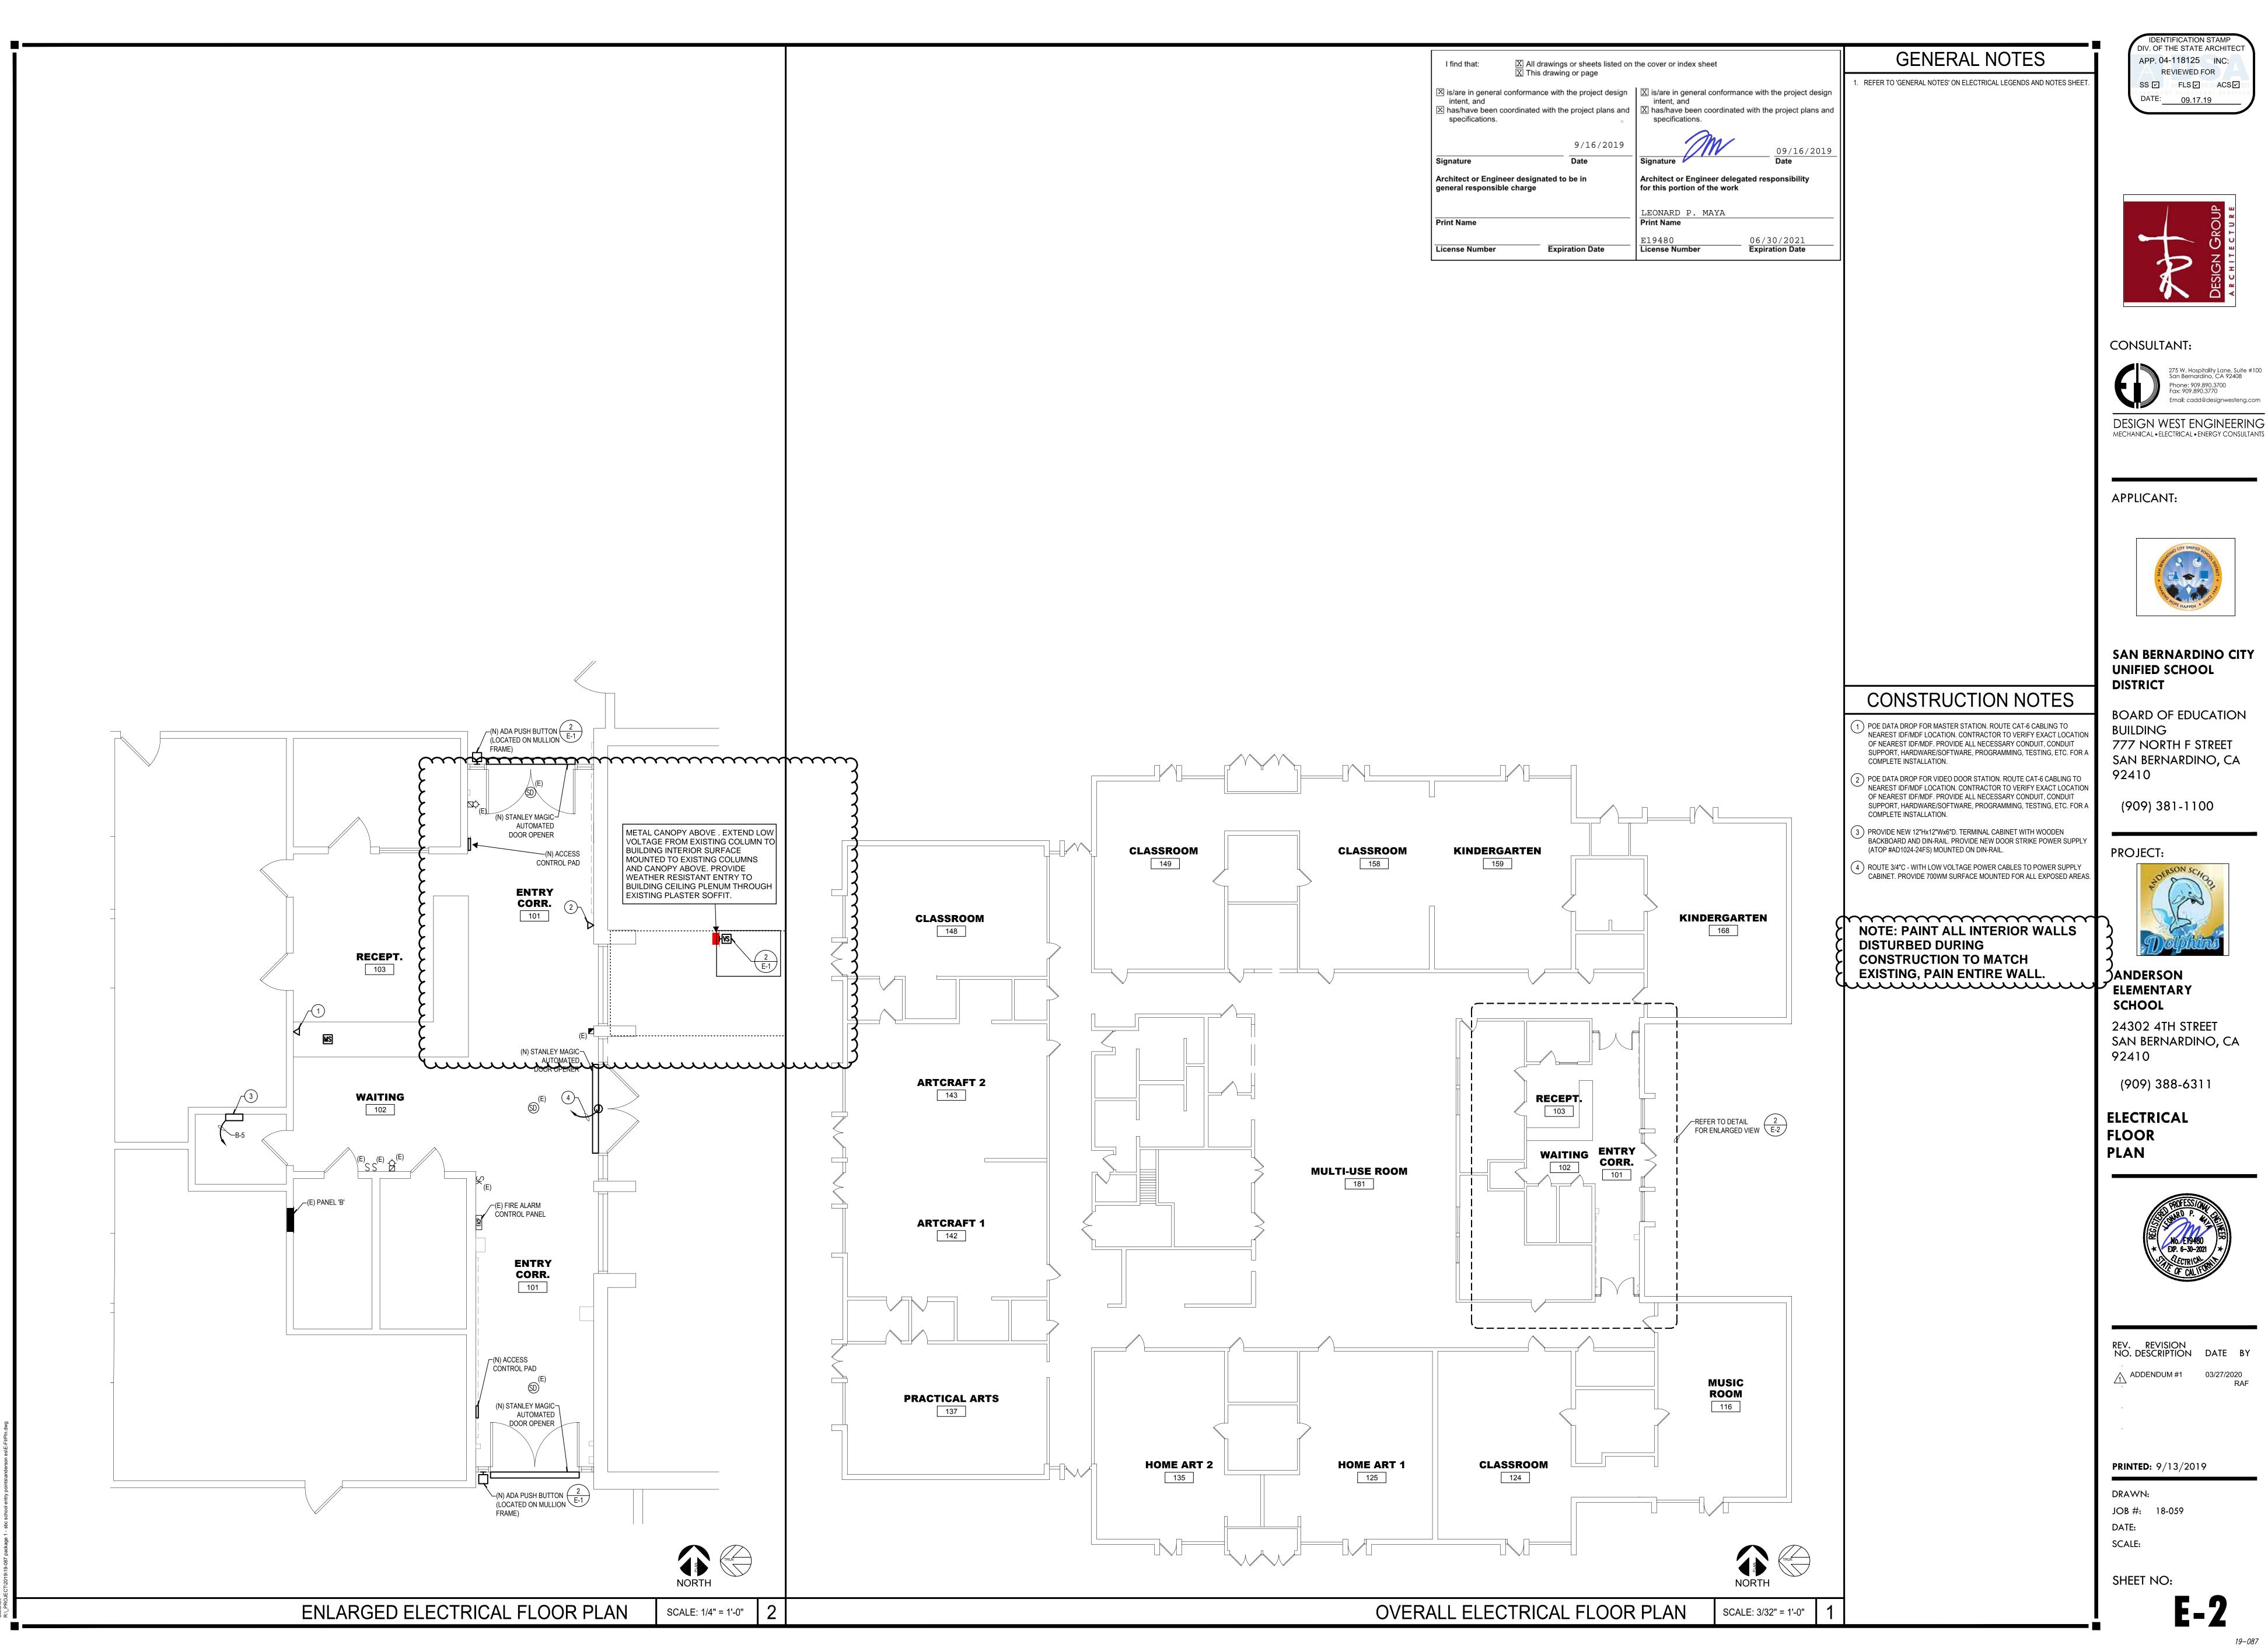

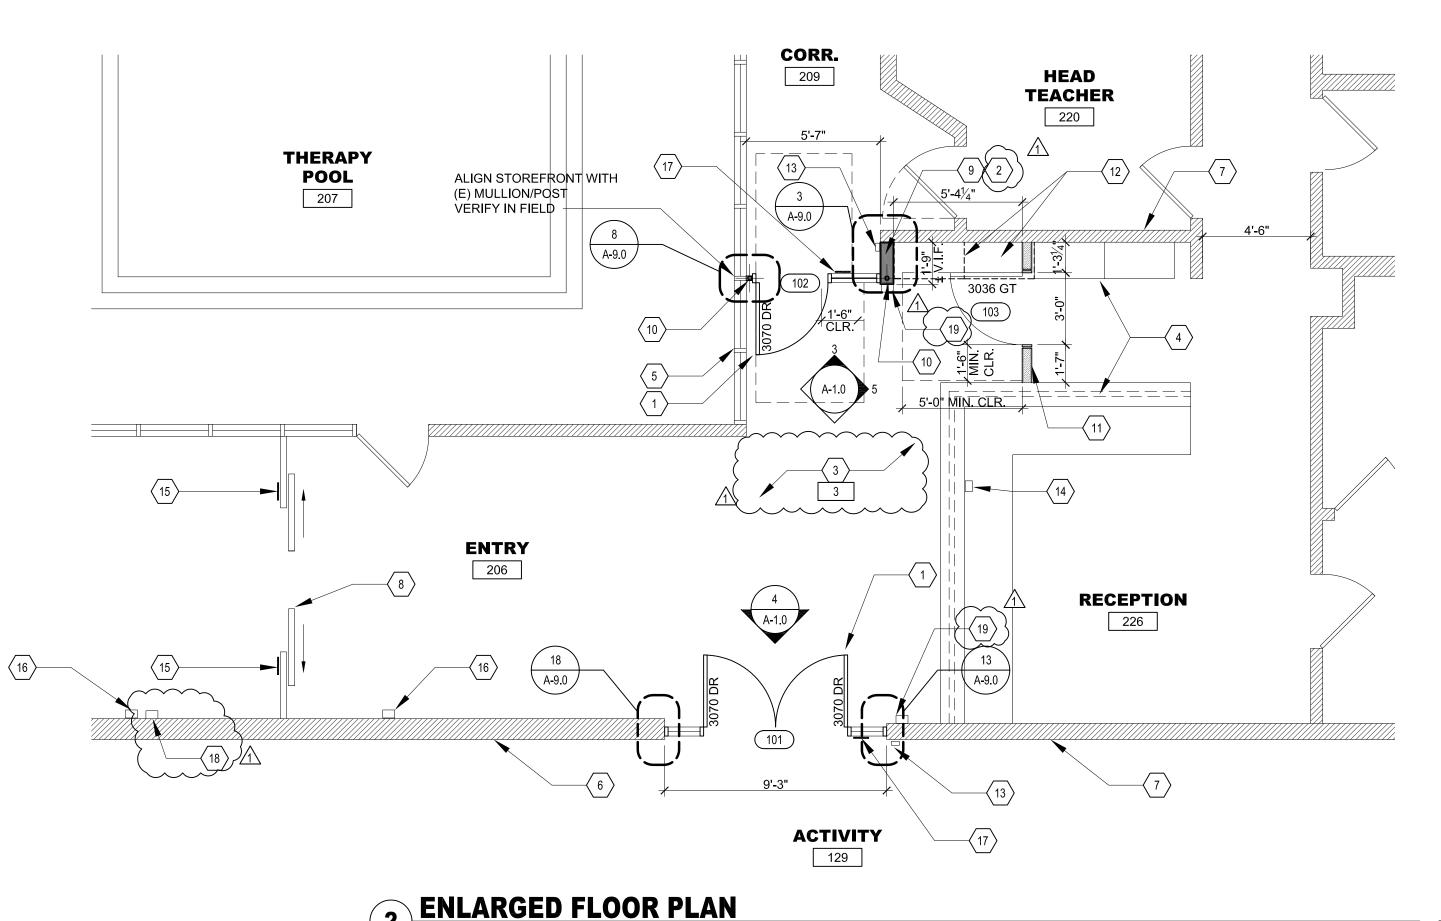

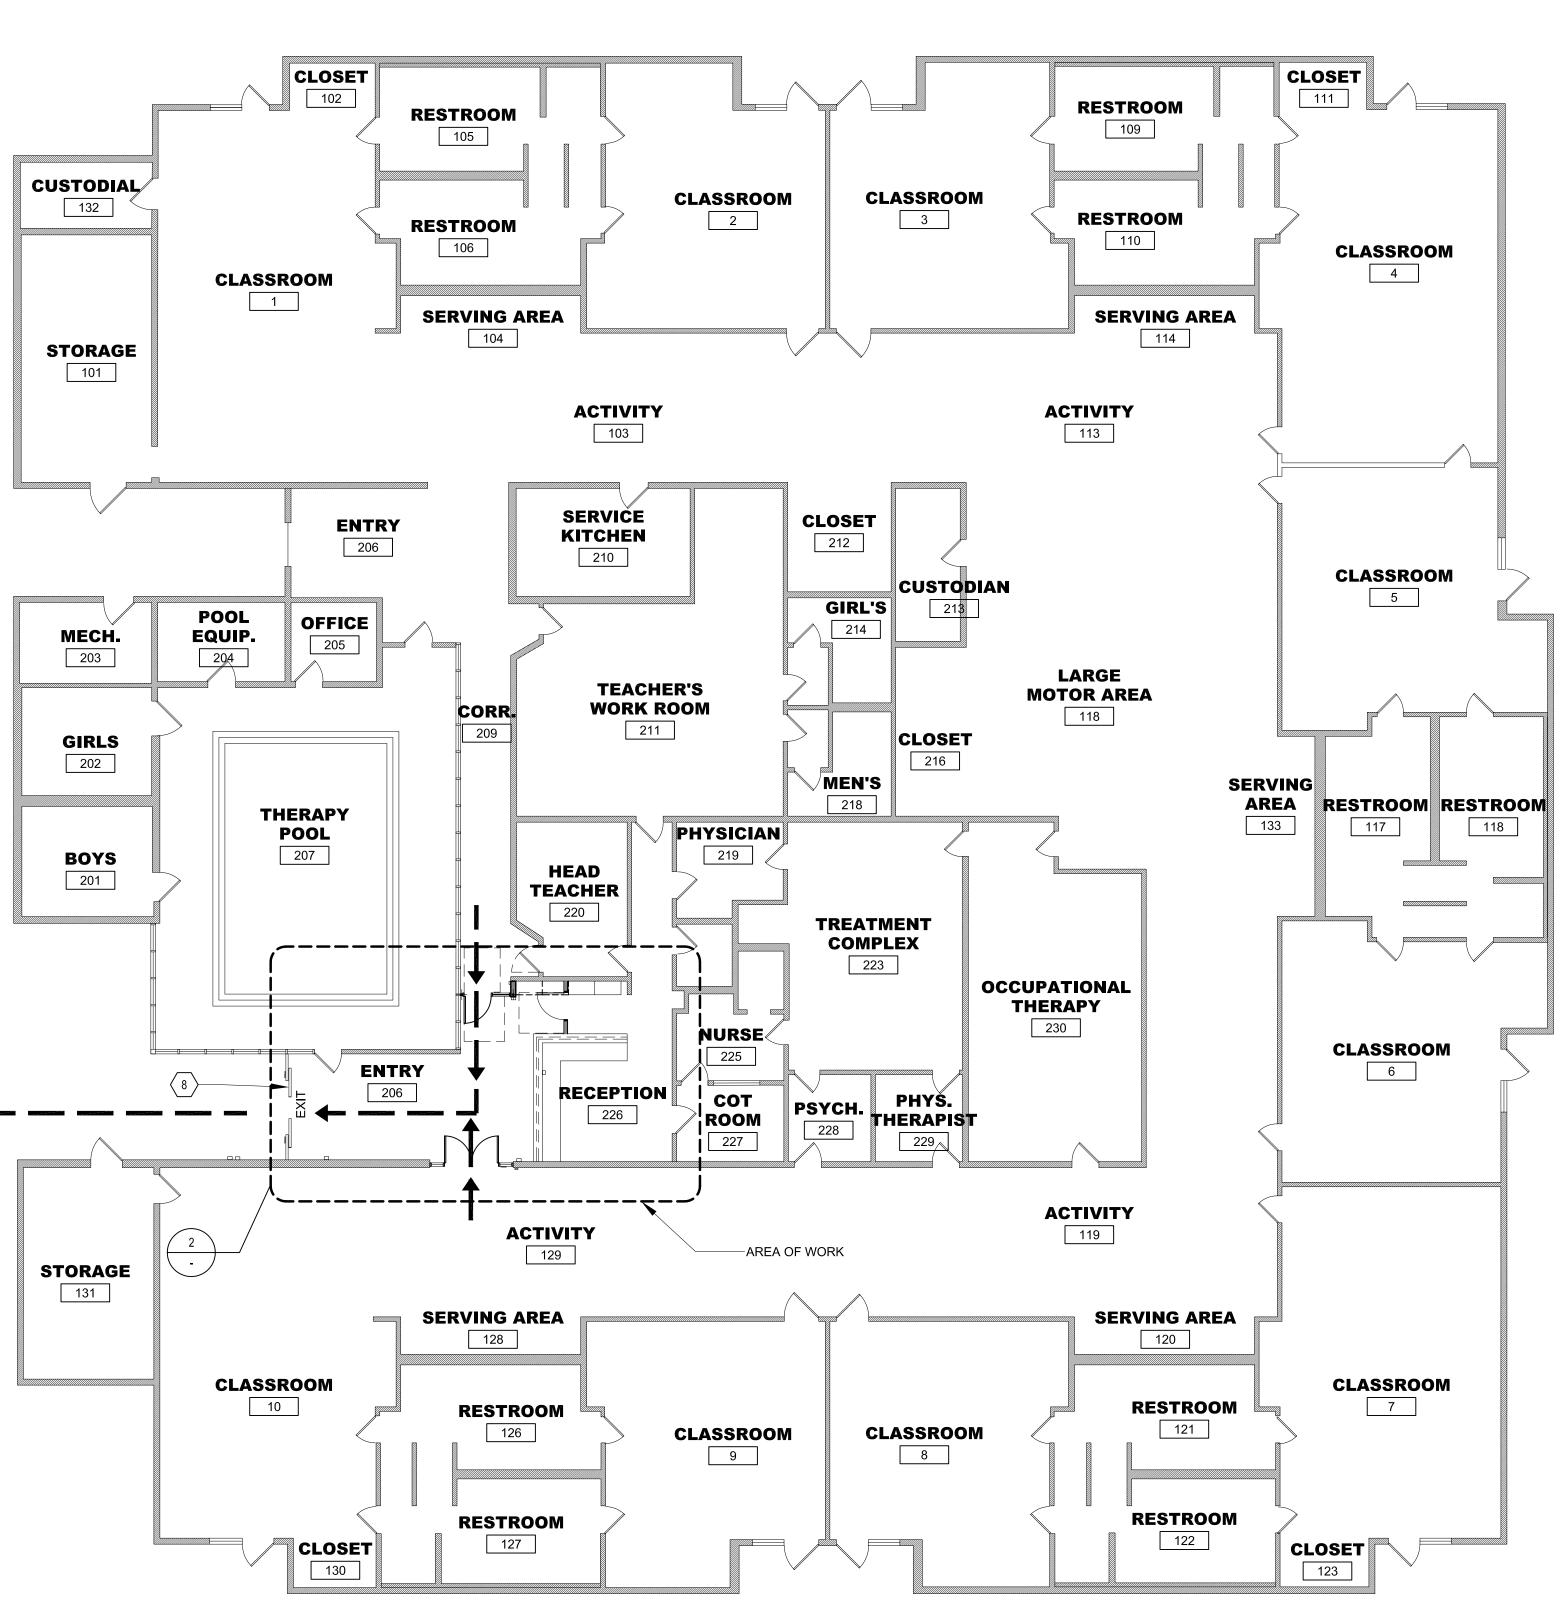

FLOOR PLAN KEYNOTES

- NEW SECURITY ENTRY POINT WITH (N) DOOR, FRAME & SIDELITE; DOOR TO INCLUDE ELECTRIC EXIT DEVICE WITH A REMOTE CONTROL SWITCH FOR UNLATCHING TO BE AT THE RECEPTION DESK, AND AN ADA COMPLIANT AUTO OPENER WITH PUSH PLATE FOR EXITING. SEE SPECIFICATIONS; COLOR TO MATCH EXISTING.
- $\left\langle \ _{2} \ \right\rangle$ (E) ADJACENT WALL, WINDOW & TRIM; PAINT TO MATCH (E) WALLS
- (E) T-BAR CEILING, LIGHT FIXTURES, HVAC REGISTER TO REMAIN; PROTECT IN PLACE DURING CONSTRUCTION
- (E) CASEWORK TO REMAIN; PROTECT IN PLACE
- (E) MASONRY WALL W/ GYP. BD. FURRING

(E) STOREFRONT TO REMAIN; PROTECT IN PLACE

- (E) WD. STUD WALL WITH GYP. BD. EA. SIDE
- $\left\langle 8 \right\rangle$ (E) ENTRY/EXIT DOORS; PROTECT IN PLACE
- 9 (N) 2X6 STUD WALL WITH 5/8" TYPE X GYP. BD. EA SIDE.
- $\langle 10 \rangle$ (N) 2X2 STEEL COL. PER STRUCTURAL DWGS
- (N) PARTIAL HEIGHT 2X4 STUD WALL WITH SWINGING GATE W/
- LEVER LATCH/LOCK AND SELF CLOSING HINGES (12) REMOVE EXISTING CASEWORK/CABINETS FOR NEW GATE
- $\langle 13 \rangle$ NEW ADA ACCESS CONTROL PUSH PLATE
- (N) ACCESS CONTROL DEVICE TO OPEN DOORS 101 AND 102, SEE SPEC AND ELEC. PLANS
- $\left\langle 15 \right\rangle$ (E) ADA ACCESSIBLE ENTRANCE SIGN TO REMAIN
- $\left\langle 16 \right\rangle$ (E) ADA ACCESS CONTROL PUSH PLATE
- (N) TACTILE EXIT ROUTE SIGN, SEE DETAIL
- (18) (N) ENTRY POINT ACCESS DEVICE $\langle 19 \rangle$ (N) REMOTE ACCESS CONTROL BUTTON

DEMOLITION NOTES

- G.C. SHALL DEMO PORTIONS OF WALL AT NEW STOREFRONT ATTACHMENT POINTS FOR THE INSTALLATION OF BACKING, HIGH AND LOW VOLTAGE LINES. PATCH WALL WITH GYP BD TO MATCH EXISTING AND APPLY BASE AND PAINT AS REQUIRED TO RETURN WALL TO ORIGINAL STATE.
- 2 G.C. SHALL REMOVE AND RELOCATE WALL ACCESSORIES PER THE DIRECTION OF SITE FACILITIES OPERATOR.
- 3 CEILING MAY NEED TO BE REMOVED & REINSTALLED FOR THE FULL INSTALLATION. DAMAGED CEILING TILES SHALL BE REPAIRED WITH LIKE. IF CEILING IS UNABLE TO BE REPAIRE G.C. SHALL INSTALL NEW SUSPENDED ACOUSTICAL CEILING SYSTEM TO MATCH EXISTING.
- 4 G.C. SHALL DEMO EXISTING WALL AND MODIFY EXISTING CASEWORK AS NEEDED TO INSTALL POWER AND LOW VOLTAGE CONTROL WIRING FOR ENTRY POINT DOORS. EXACT PLACEMENT OF CONTROLS SHALL BE DETERMINED BY SITE FACILITIES OPERATOR.

GENERAL NOTES

1. T-BAR CEILING IS NOT AFFECTED BY THIS SCOPE AND (E) T-BAR CEILINGS SHALL BE PROTECTED IN PLACE

COUNTER. SEE SPECIFICATION

- PATCH, REPAIR, TEXTURE & PAINT ALL ADJACENT (INTERIOR) WALLS & TRIM OF AFFECTED SCOPE TO MATCH EXISTING 3. G.C. SHALL MODIFY EXISTING AUTOMATED DOOR SYSTEM TO
- 4. PROTECT FLOORING IN PLACE, DAMAGED FLOORING SHALL BE REPLACED WITH LIKE.

ACCEPT NEW ENTRY POINT ACCESS CONTROLS AT RECEPTION

APPLICANT:



SAN BERNARDINO CITY **UNIFIED SCHOOL** DISTRICT

BOARD OF EDUCATION BUILDING 777 NORTH F STREET SAN BERNARDINO, CA 92410

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PROJECT:



HARMON ELEMENTARY **SCHOOL**

4865 N STATE STREET SAN BERNARDINO CA, 92407


(909) 880-6616

LEGEND



ACCESSIBLE PATH OF TRAVEL AS INDICATED ON PLAN IS A BARRIER-FREE ACCESS ROUTE WITHOUT ANY ABRUPT LEVEL CHANGES EXCEEDING 1/2" IF BEVELED AT 1:2 MAX. SLOPE, OR VERTICAL LEVEL CHANGES NOT EXCEEDING 1/4" MAX., AND SLOPE IN THE DIRECTION OF TRAVEL IS LESS THAN 5%. UNLESS OTHERWISE INDICATED. ACCESSIBLE PATH OF TRAVEL SHALL BE MAINTAINED FREE OF OVERHANGING OBSTRUCTIONS TO 80" MINIMUM, AND PROTRUDING OBJECTS GREATER THAN 4" PROJECTION FROM WALL AND ABOVE 27" AND LESS THAN 80". ARCHITECT SHALL VERIFY THAT THERE ARE NO BARRIERS IN THE PATH OF TRAVEL.

FLOOR PLAN/ ENLARGED INTERIOR ELÉVATION

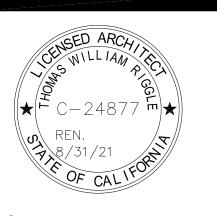

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WALL LEGEND

EXISTING WALL


NEW WALL

NEW PARTIAL HEIGHT WALL

3/27/20 DATE: AS NOTED

DRAWN: JM

PRINTED: 3/27/2020

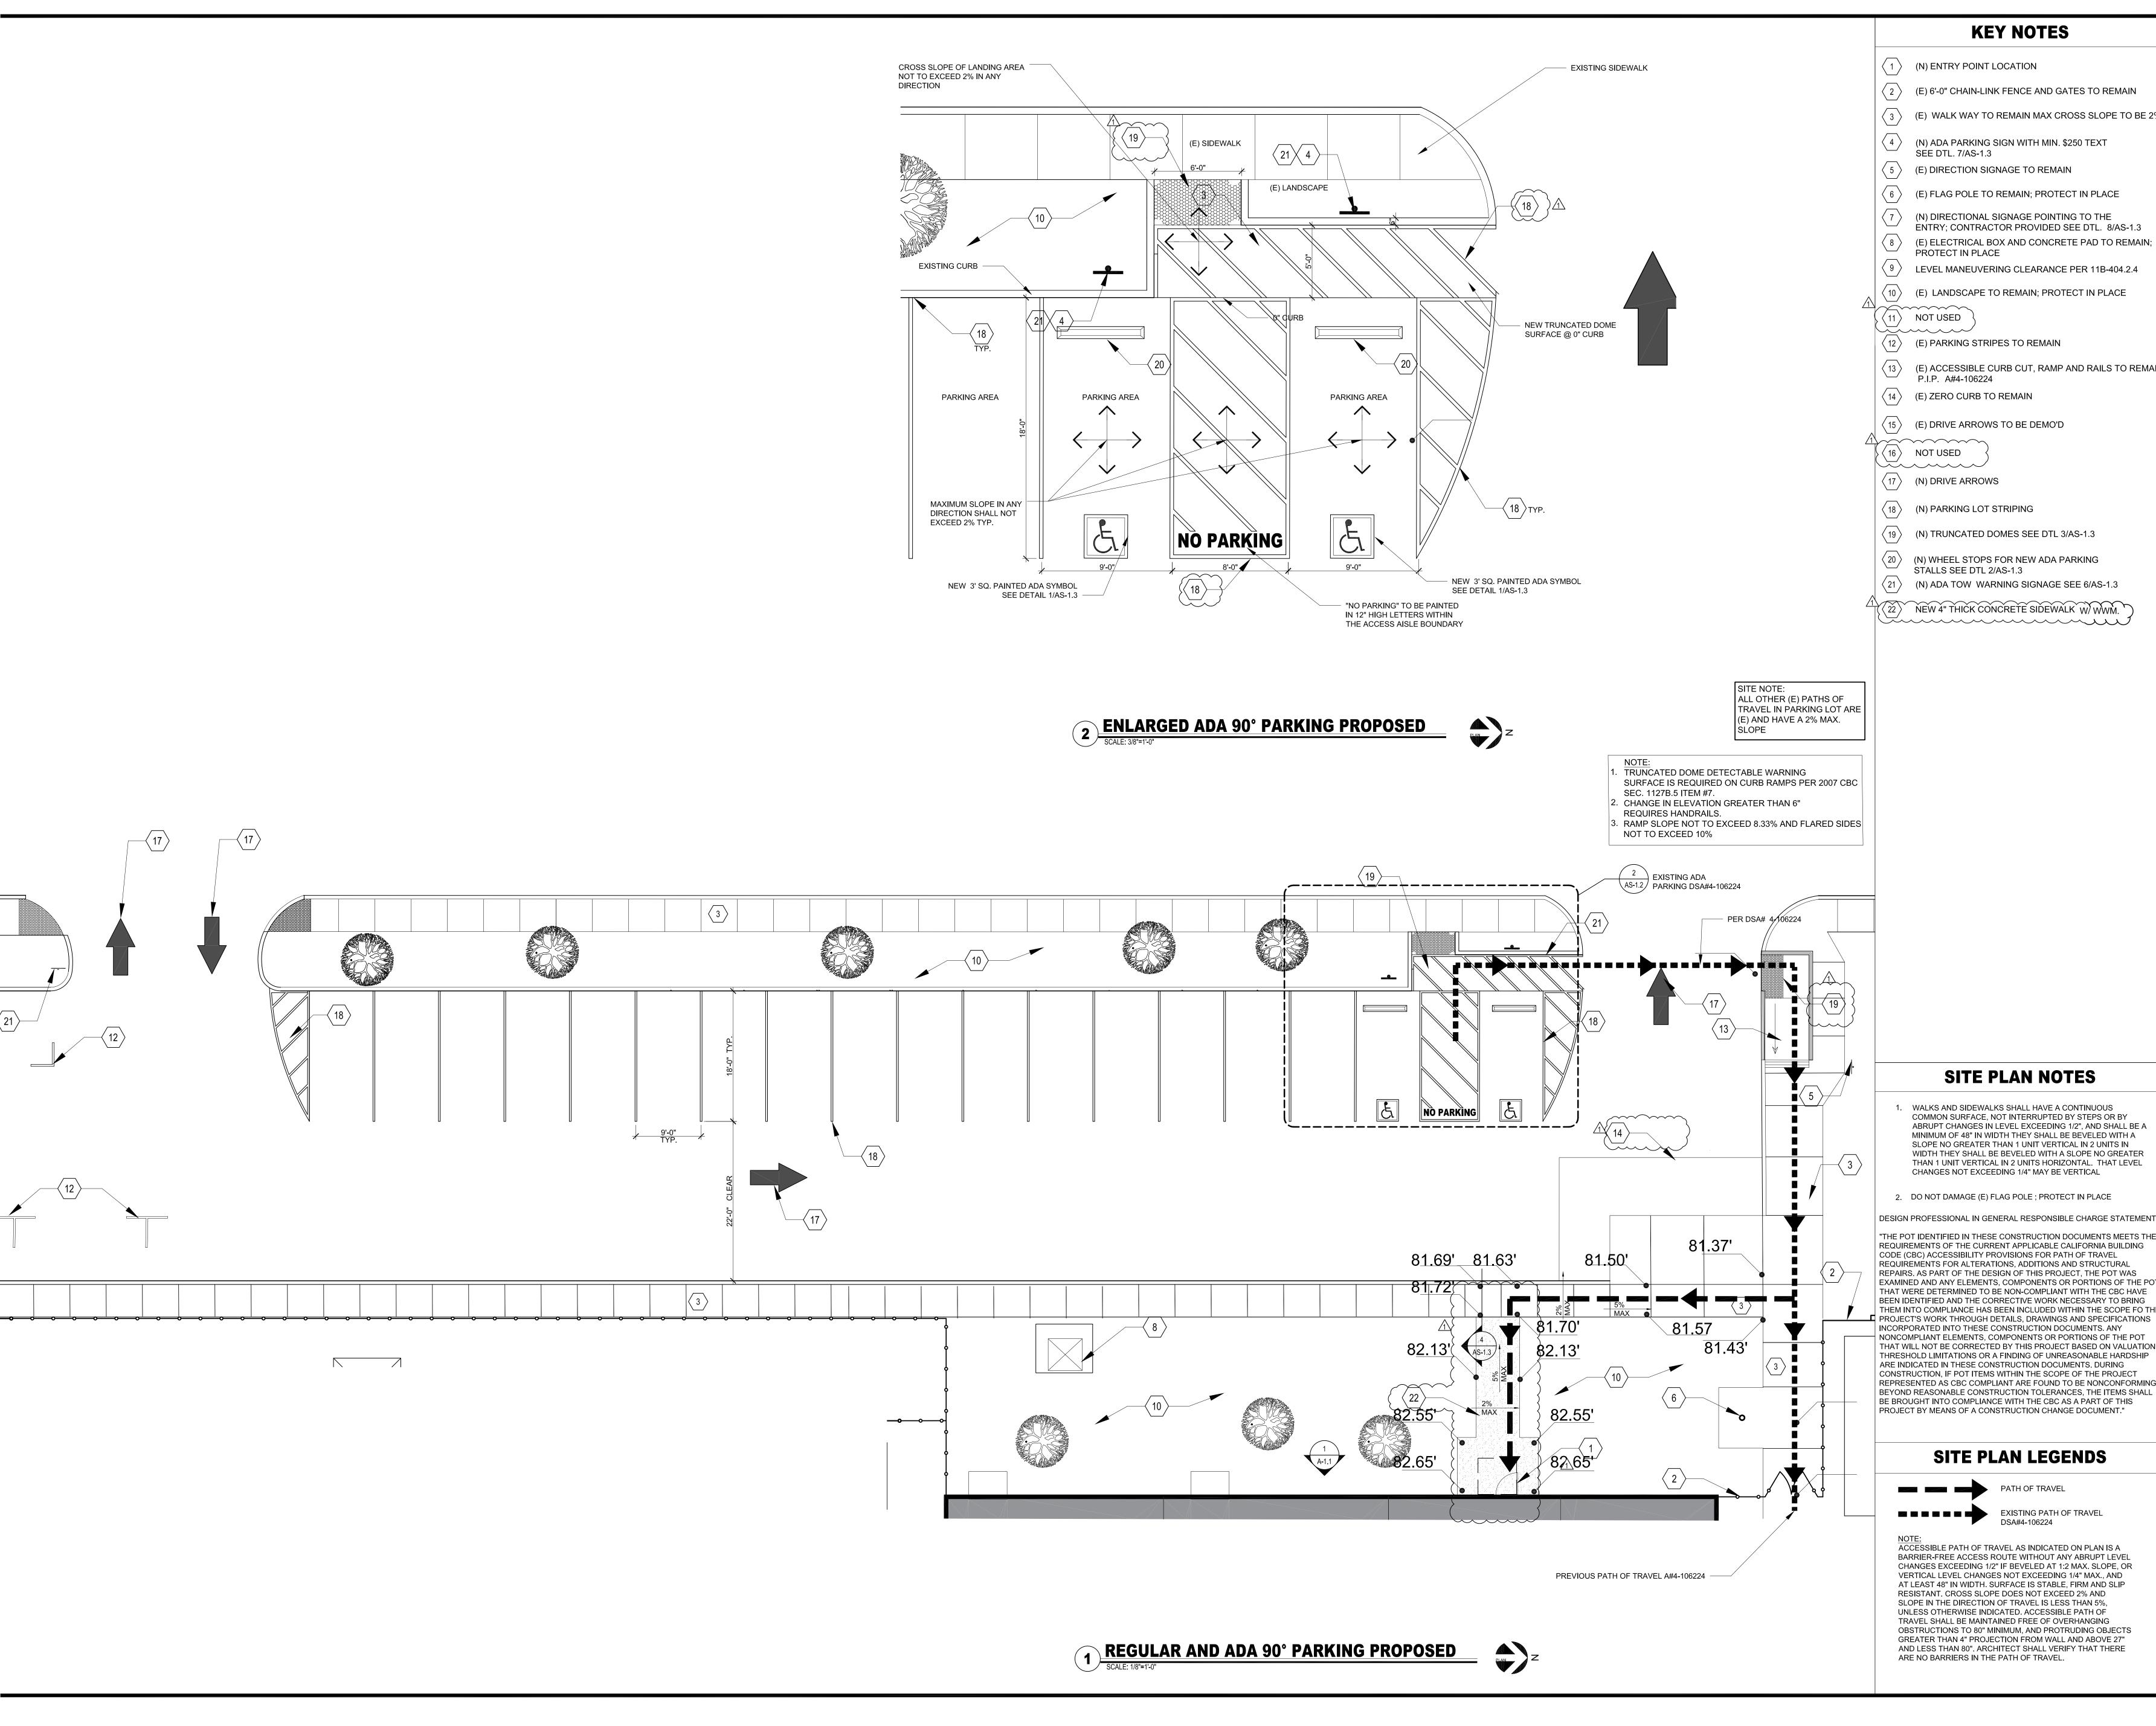

KEY NOTES

- $\langle 1 \rangle$ (N) ENTRY POINT LOCATION
- \langle 2 \rangle (E) 6'-0" CHAIN-LINK FENCE AND GATES TO REMAIN
- $\left\langle 3 \right\rangle$ (E) WALK WAY TO REMAIN MAX CROSS SLOPE TO BE 2%
- (N) ADA PARKING SIGN WITH MIN. \$250 TEXT SEE DTL. 7/AS-1.3
- (5) (E) DIRECTION SIGNAGE TO REMAIN
- (6) (E) FLAG POLE TO REMAIN; PROTECT IN PLACE
- (N) DIRECTIONAL SIGNAGE POINTING TO THE ENTRY: CONTRACTOR PROVIDED SEE DTL. 8/AS-1.3
- (9) LEVEL MANEUVERING CLEARANCE PER 11B-404.2.4
- (E) LANDSCAPE TO REMAIN; PROTECT IN PLACE

- (E) ACCESSIBLE CURB CUT, RAMP AND RAILS TO REMAIN;
- (E) ZERO CURB TO REMAIN
- $\langle 15 \rangle$ (E) DRIVE ARROWS TO BE DEMO'D

- $\langle 17 \rangle$ (N) DRIVE ARROWS
- $\langle 18 \rangle$ (N) PARKING LOT STRIPING
- (N) WHEEL STOPS FOR NEW ADA PARKING STALLS SEE DTL 2/AS-1.3
- $\langle 21 \rangle$ (N) ADA TOW WARNING SIGNAGE SEE 6/AS-1.3

PATH OF TRAVEL

DSA#4-106224

22 NEW 4" THICK CONCRETE SIDEWALK W WWM.



APPLICANT:



SAN BERNARDINO CITY **UNIFIED SCHOOL** DISTRICT

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PROJECT:



KENDALL ELEMENTARY **SCHOOL**

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PROP. SITE PARKING



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REV. REVISION NO. DESCRIPTION DATE BY ↑ ADDENDUM #1 03/27/2020

PRINTED: 3/27/2020

DRAWN: ____ JOB #: 18-059 DATE: 3/27/20

SCALE: x/x'' = 1'-0''

LUMINAIRE SCHEDULE

TYPE	VOLTS	WATTAGE	LAMPS	MOUNTING	FIXTURE DESCRIPTION	MANU	CATALOG #	NOTES	SYMBOL
F1	120	21/2,260	LED 3500K	CEILING SURFACE	1'x4' SURFACE MOUNTED LED FIXTURE WITH 0-10V DIMMING DRIVER.	LITHONIA	TXL4-20L-FW-A12- EZ1-LP835	COORDINATE COLOR OF FINISH WITH ARCHITECT	

GENERAL NOTES

. REFER TO 'GENERAL NOTES' ON ELECTRICAL LEGENDS AND NOTES SHEET.

DEMOLITION NOTES

DEMOLISH EXISTING LIGHT FIXTURE AND WALL SWITCH. EXISTING LIGHTING CIRCUIT TO BE REUSED AND RECONNECTED TO NEW LED 1'x4' SURFACE MOUNTED FIXTURE, WITH WALL MOUNTED OCCUPANCY

RECEPTACLE, PER REMODEL PLANS.

SENSOR AND SWITCH.

> DEMOLISH EXISTING RECEPTACLES AND CIRCUIT BACK TO CEILING J-BOX. EXISTING CIRCUIT TO BE REUSED FOR CONNECTION TO NEW GFCI





CONSULTANT:



DESIGN WEST ENGINEERING MECHANICAL • ELECTRICAL • ENERGY CONSULTANTS



CONSTRUCTION NOTES

-) POE DATA DROP FOR MASTER STATION. ROUTE CAT-6 CABLING TO NEAREST IDF/MDF LOCATION. CONTRACTOR TO VERIFY EXACT LOCATION OF NEAREST IDF/MDF. PROVIDE ALL NECESSARY CONDUIT, CONDUIT SUPPORT, HARDWARE/SOFTWARE, PROGRAMMING, TESTING, ETC. FOR A COMPLETE INSTALLATION.
- NEAREST IDF/MDF LOCATION. CONTRACTOR TO VERIFY EXACT LOCATION
 OF NEAREST IDF/MDF. PROVIDE ALL NECESSARY CONDUIT, CONDUIT
 SUPPORT, HARDWARE/SOFTWARE, PROGRAMMING, TESTING, ETC. FOR A COMPLETE INSTALLATION.
- PROVIDE NEW 12"Hx12"Wx6"D. TERMINAL CABINET WITH WOODEN BACKBOARD AND DIN-RAIL. PROVIDE NEW DOOR STRIKE POWER SUPPLY (ATOP #AD1024-24FS) MOUNTED ON DIN-RAIL.
- ROUTE 3/4"C WITH LOW VOLTAGE POWER CABLES TO POWER SUPPLY CABINET. PROVIDE 700WM SURFACE MOUNTED FOR ALL EXPOSED AREAS.
- PROVIDE CONNECTION TO NEW EXHAUST FAN FROM EXISTING LIGHTING
- CONTROLS SHALL BE USED. CONTRACTOR TO VERIFY EXISTING CIRCUIT NUMBER FEEDING LIGHTING IN THIS SPACE AND LABEL NEW JUNCTION BOX WITH PANEL NAME AND CIRCUIT NUMBER.
- PROVIDE NEW CEILING SURFACE MOUNTED LIGHT FIXTURE. REFER TO MOUNTING DETAIL: $\left(\frac{3}{E-1}\right)$
- PROVIDE NEW FIRE ALARM DEVICE AND RECONNECT TO NEARBY EXISTING FIRE ALARM CIRCUIT. PROVIDE ALL NECESSARY CONDUITS, CABLING, J-BOXES, PROGRAMMING AND TESTING FOR A COMPLETE INSTALLATION.

APPLICANT:



SAN BERNARDINO CITY **UNIFIED SCHOOL** DISTRICT

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(909) 381-1100

PROJECT:



KENDALL ELEMENTARY **SCHOOL**

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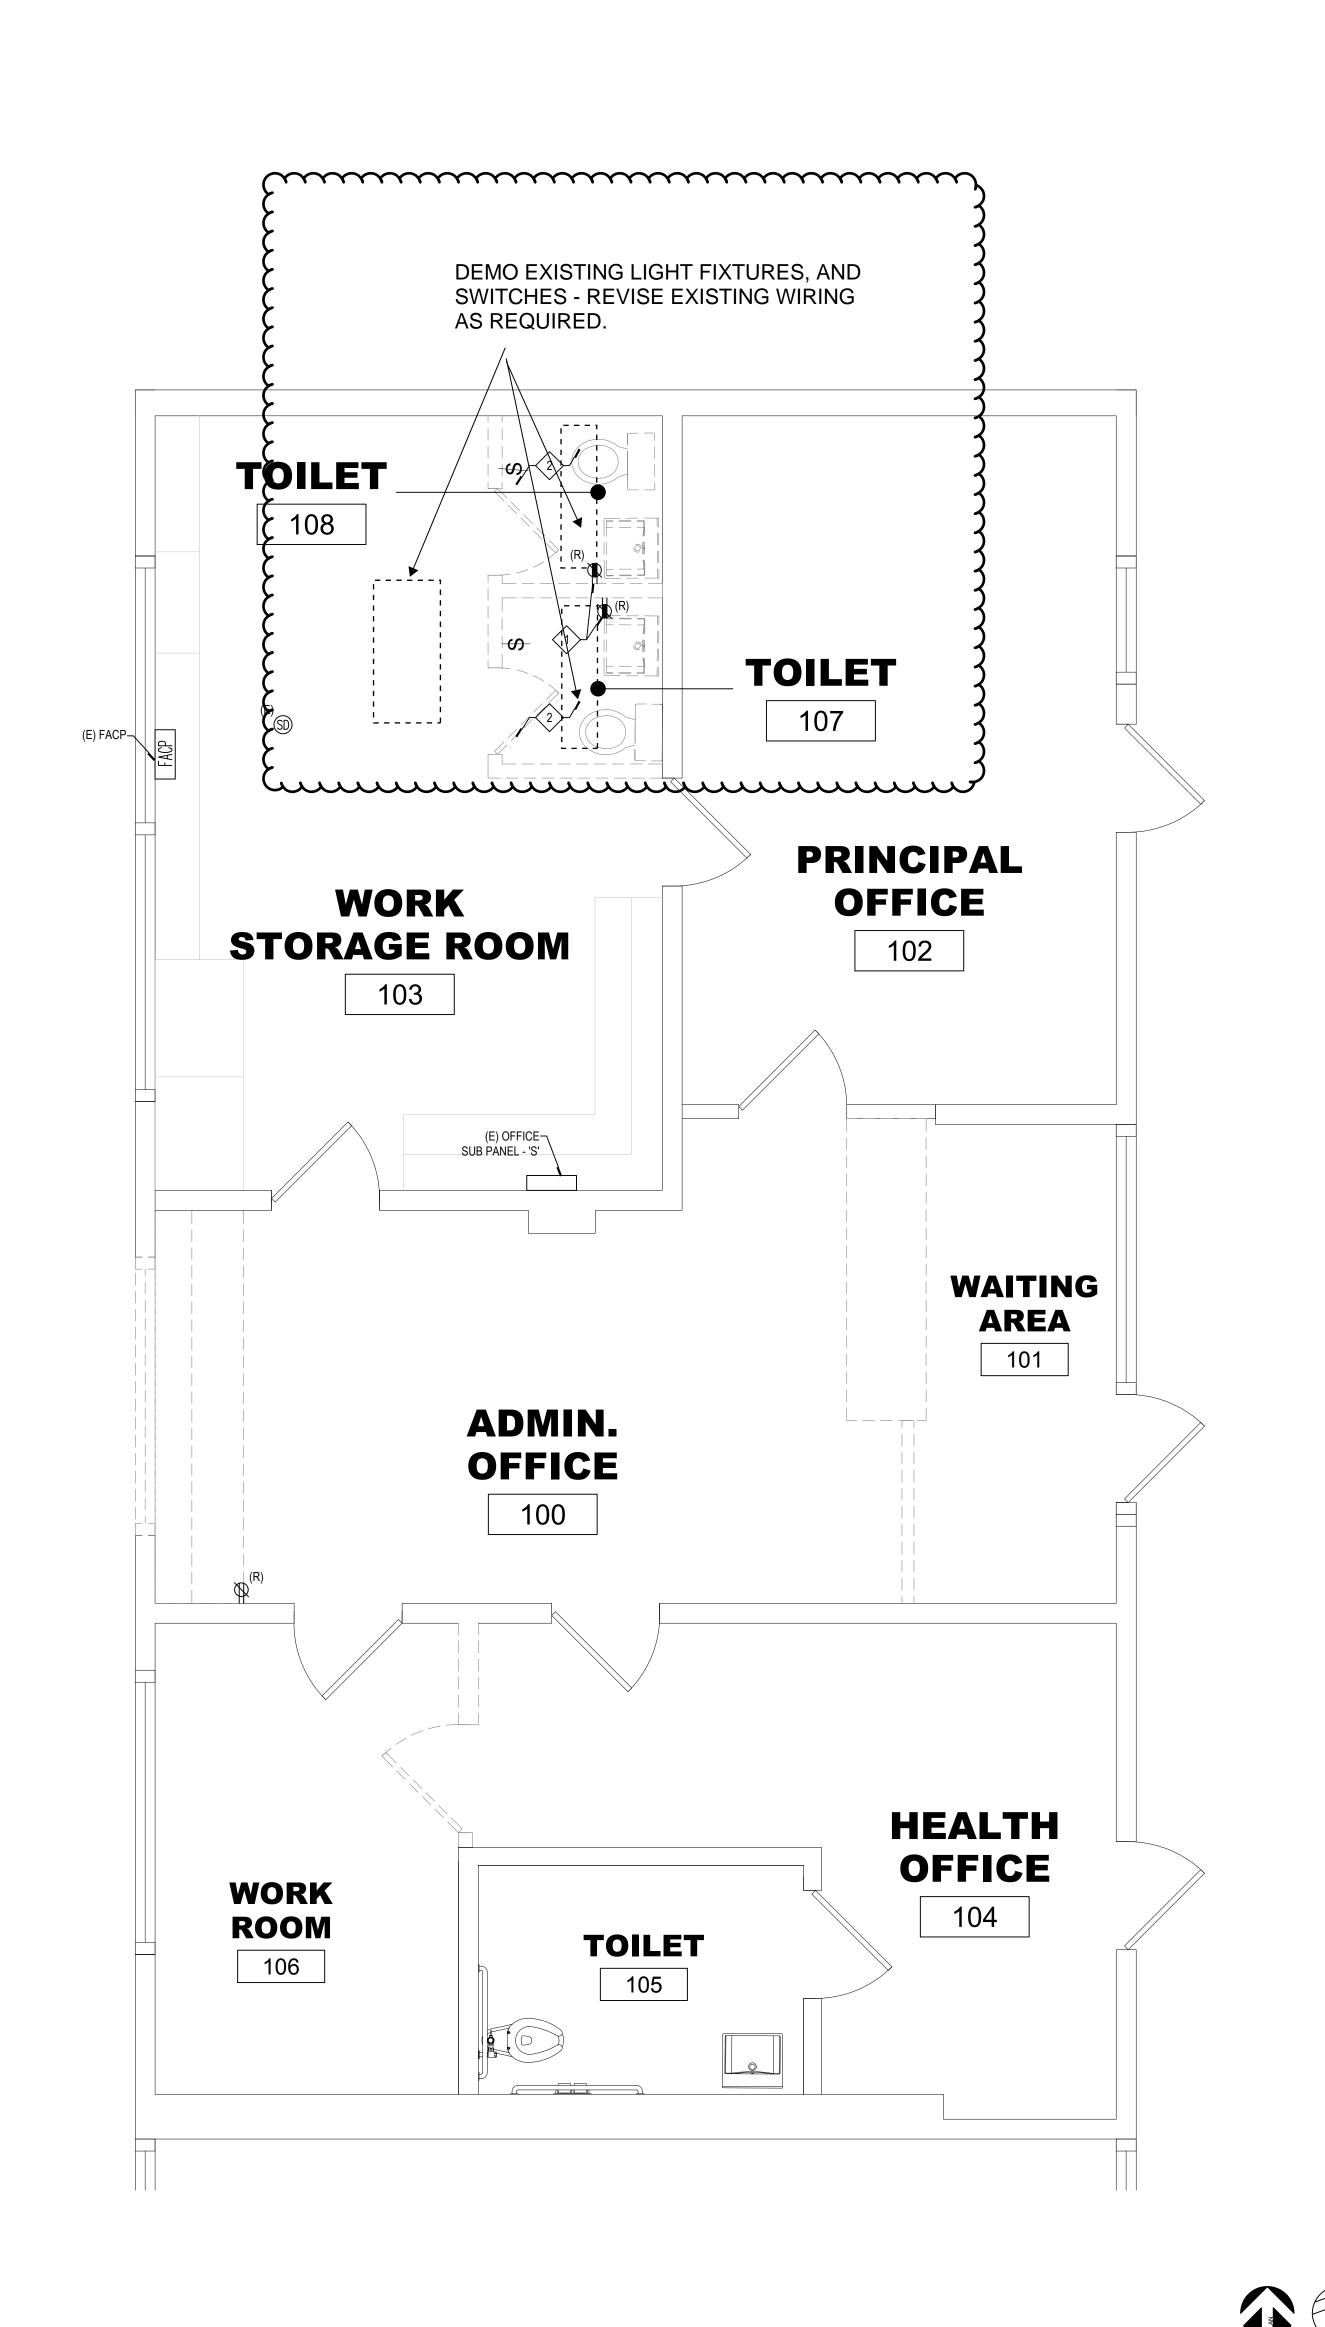
ELECTRICAL FLOOR PLANS



REV. REVISION NO. DESCRIPTION DATE BY ADDENDUM #1 03/27/2020


PRINTED: 8/12/2019

SHEET NO:



ELECTRICAL DEMOLITION FLOOR PLAN

SCALE: 3/8" = 1'-0"

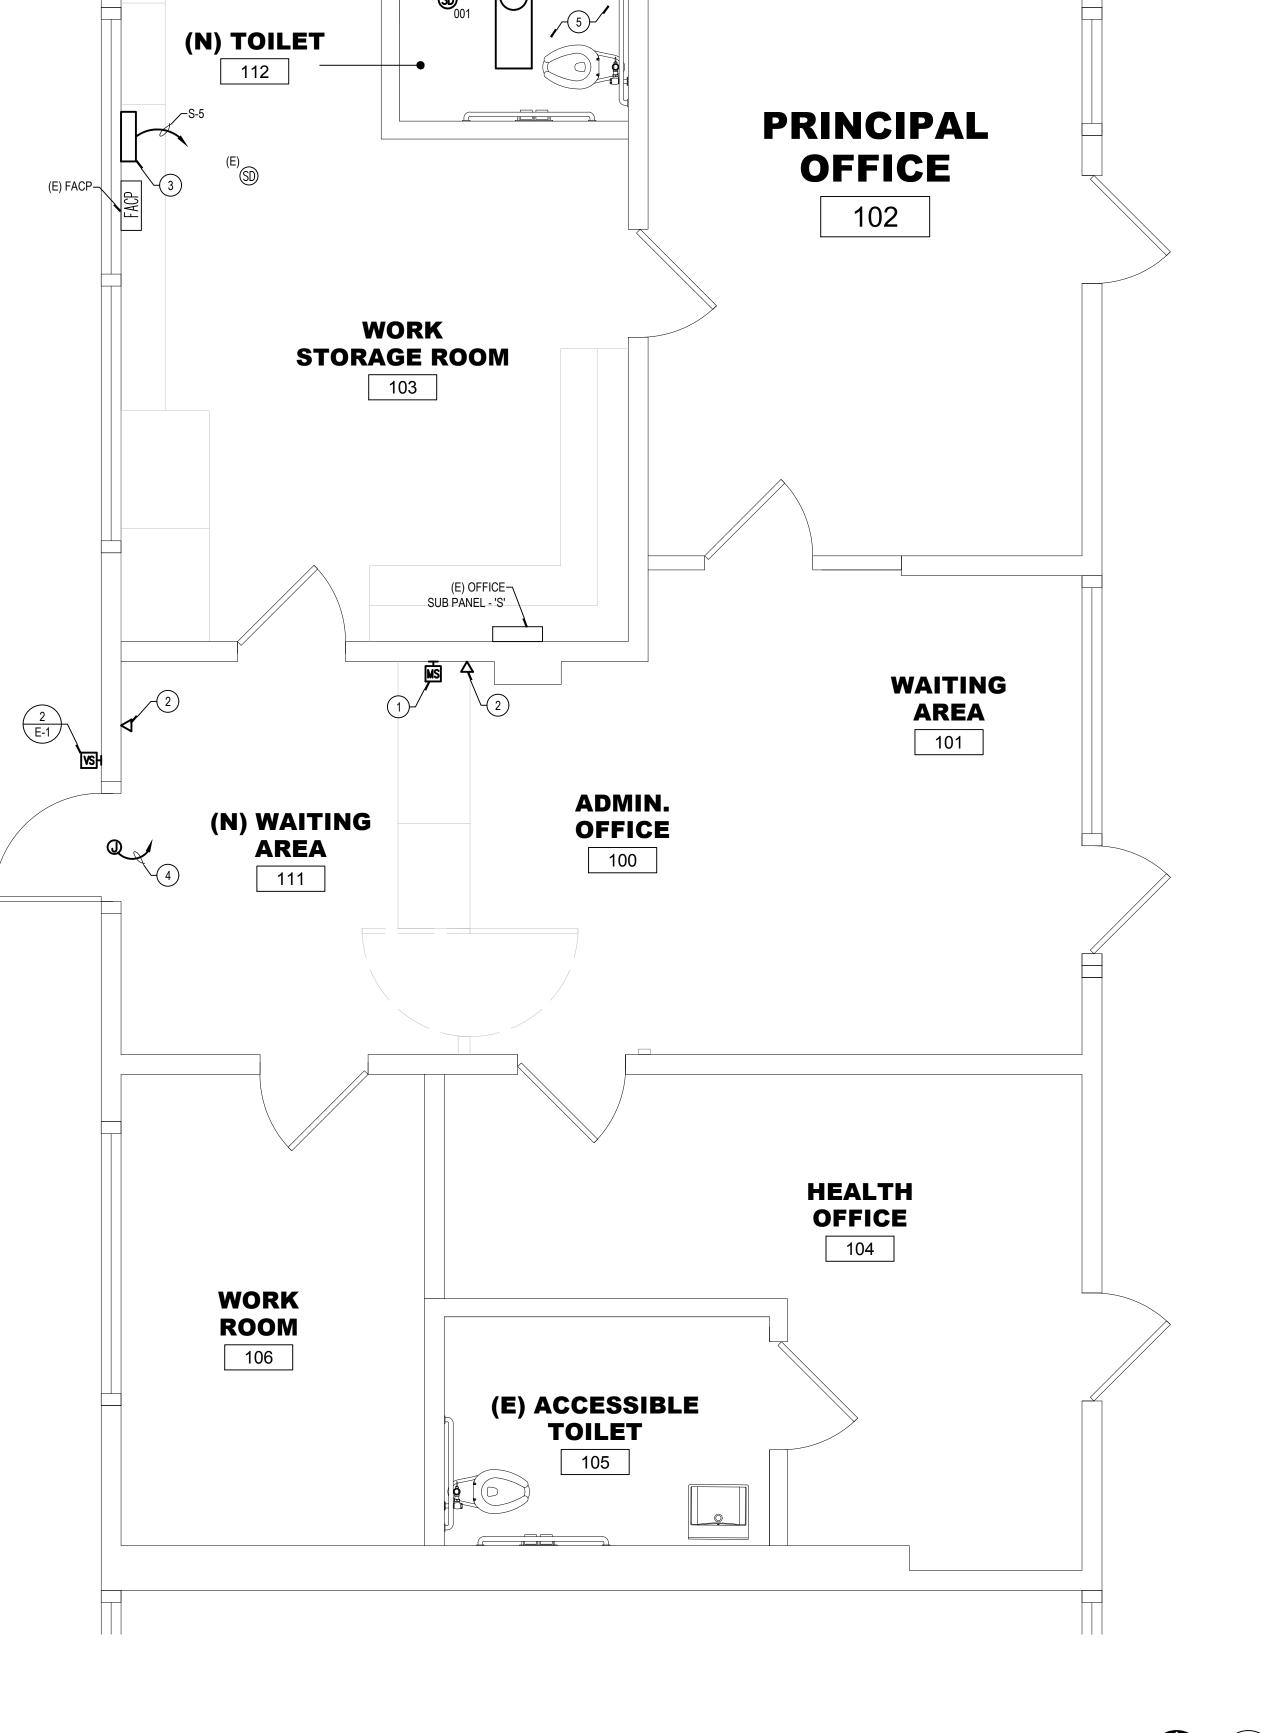

ELECTRICAL REMODEL FLOOR PLAN

