

September 12, 2019

TO: All Bidders FROM: Mark Graham

PROJECT: Cole Elementary School Modernization

1719900.41

SUBJECT: Addendum 2

DSA : 04-117697, File 36-55

The following changes, omissions, and/or additions to the Project Manual and/or Drawings shall apply to proposals made for and to the execution of the various parts of the work affected thereby, and all other conditions shall remain the same.

Careful note of the Addendum shall be taken by all parties of interest so that the proper allowances may be made in strict accordance with the Addendum, and that all trades shall be fully advised in the performance of the work which will be required of them.

Bidder shall acknowledge receipt of this Addendum in the space provided on the Bid Form. Failure to do so may subject Bidder to disqualification.

In case of conflict between Drawings, Project Manual, and this Addendum, this Addendum shall govern.

2. GENERAL

2.1 Site work to be completed during a school break only. The rest of the work can be completed at any time during the contract.

PROJECT MANUAL

- 2.2 SECTION 07 21 16 BLANKET INSULATION
 - A. Add the attached Section 07 21 16 in its entirety.
- 2.3 SECTION 09 68 13 TILE CARPETING
 - A. Article 2.2: Add Paragraph G to read as follows:
 - 1. G. Base product is "Mainboard" from all GLITCH ART COLLECTION from Mannington. Colors to be selected by Architect from product line.
 - B. Article 2.1: Revise Paragraph C to read as follows:
 - 1. C. Mannington Mills, Inc., Style: GLITCH ART COLLECTION, Pattern: Mainboard, www.mannington.com.

Addendum 2 Cole Elementary School Modernization Project 1719900.41 04-117697 / File 36-55 September 12, 2019 Page 2

- 2 .4 SECTION 12 24 00 WINDOW SHADES CLUTCH XD OPERATED WINDOW SHADES
 - A. Add the attached section in its entirety.
- 2.5 SECTION 12 24 13 ROLLER SHADES
 - A. Delete this Section 12 24 13 in its entirety.

DRAWINGS

Architectural

- 2.6 DRAWING A1.1 DEMOLITION SITE PLAN
 - A. Add Reference Notes 0129, 0130, and 0131 per the attached Drawing A01.
- 2.7 DRAWING A1.2 NEW SITE PLAN
 - A. Detail 2 Add Reference Note 0210 per the attached Drawing A02.
 - B. Detail 3 Add Reference Notes 0132 and 1301 per the attached Drawing A03.
 - C. Detail 4A Add Reference Note 1301 per the attached Drawing A04.
- 2.8 DRAWING A2.1 DEMO AND NEW FLOOR AND CEILING PLANS
 - A. Detail 1 Add Reference Notes 0110 and 0136 per the attached Drawing A05.
 - B. Detail 2
 - 1. Add dimensions for new concrete slab and add Reference Notes 0601, 0903 and 1302 per the attached Drawing A06.
 - 2. Revised Reference Note 1014 to read as follows:
 - "(N) 86" ACTIVPANEL WITH MOUNTING BRACKET, REFER TO THE ATTACHED DRAWING A12 FOR BACKING."
 - 3. Add New Elevation 14/A11 per the attached Drawing A11.
 - C. Detail 3
 - 1. Add Reference Notes 0133 and 0134 per the attached Drawing A07.

Addendum 2 Cole Elementary School Modernization Project 1719900.41 04-117697 / File 36-55 September 12, 2019 Page 3

- 2. Revised Reference Note 0122 to read as follows:
 - "(E) SURFACE MOUNTED SOAP DISPENSER TO BE REMOVED AND RETURNED TO THE OWNER, REMOVE DAMAGED TILE, AND PATCH WALL WITH NEW TILE TO MATCH EXISTING."
- D. Detail 5 -Add Reference Notes 0133 and 0135 per the attached Drawing A08.
- E. Detail 6
 - 1. Relocate the lighting fixture location per the attached Drawing A09.
 - 2. Revised Reference Note 2602 to read as follows:
 - "2602 REINSTALL (E) LIGHTING SWITCH TO 48" TO THE TOP OF OUTLET."
- F. Detail 7 Add Reference Note 0138 per the attached Drawing A/A15.
- G. Detail 8 Add note:
 - 1. "Paint ceiling grid, Color DE6375 Castlerock, Dunn Edwards."
 - 2. Add Reference Note 0702 and dimensions per the attached Drawing B/A15.
- H. Details 11 and 12 Revise window glass color, add tackboard color in Reference Note 0906, and add Reference Notes 0907 and 0908 per the attached Drawing A10.
- I. Detail 13 Add Reference Note 0908 and per the attached Drawing A11.
- J. Detail 16 Revise per the attached Drawing A13.

<u>Electrical</u>

- 2.9 DRAWING E0.3 PANEL AND LIGHTING FIXTURE SCHEDULES
 - A. Added new Circuit #14 for TV monitor on Panel E1B per the attached Drawing E01.
- 2 .10 DRAWING E2.1 DEMO, LIGHTING, POWER AND SIGNAL AND FIRE ALARM PLANS
 - A. Detail 1 Changed keynote number for existing projector to be removed per the attached Drawing E02.

Addendum 2 Cole Elementary School Modernization Project 1719900.41 04-117697 / File 36-55 September 12, 2019 Page 4

- B. Detail 3 Added new power and data receptacle for TV monitor, removed existing projector, and added Keynotes 19 and 20 per the attached Drawing E03.
- C. Revise the second "KEY NOTES" located near the middle of the drawing to "GENERAL NOTES".
- D. Revised Keynote 5a to state:

"IN FLOOR RACEWAY SYSTEM FOR POWER AND LOW VOLTAGE SYSTEM SIMILAR OR EQUAL TO LEGRAND - WALKERDUCT. REFER TO DETAIL 6 ON DRAWING E3.1. POWER: #2 DUCT; SIGNAL: #4 DUCT"

E. Revised Keynote 5b to state

"JUNCTION BOX COMPATIBLE TO WALKER DUCT. JUNCTION BOX SHALL BE FLUSH WITH WALKER DUCT CELL. REFER TO DETAIL 6 ON DRAWING E3.1."

2 .11 DRAWING E3.1 - DETAILS

A. Detail 6- Revise the Detail Number from 15/A2.1 to 16/A2.1.

END OF ADDENDUM 2

Submitted by,

MARK GRAHAM Architect, AIA LEED™ GA NOMA Principal

Mark Brahon

No. C26046
REN. 3/31/21

Print OF CALIFORN

MG:CTW:qs/P41719900x2-add

Attachments: Section 07 21 16 - Blanket Insulation

Section 12 24 00 - Window Shades Clutch XD Operated Window Shades Drawings A01, A02, A03, A04, A05, A06, A07, A08, A09, A10, A11, A12, A13, A14,

A/A15, B/A15, E01, E02, E03

SECTION 07 21 16

BLANKET INSULATION

1. PART 1 GENERAL

1.1 SECTION INCLUDES

Batt insulation for filling crevices in roof.

1.2 REFERENCES

- A. ASTM C665 Mineral Fiber Blanket Thermal Insulation for Light Frame Construction and Manufactured Housing.
- B. ASTM C1320 Installation of Mineral Fiber Batt and Thermal Insulation for Light Frame Construction.
- C. ASTM E84 Standard Test Method for Surface Burning Characteristics of Building Materials.
- D. CBC California Building Code, (CCR) California Code of Regulations, Title 24, Part 6.
- E. Business and Professions Code.

1.3 PERFORMANCE REQUIREMENTS

- Materials of this Section shall provide continuity of thermal and moisture barrier at building enclosure elements.
- B. Materials of this Section shall provide continuity of sound control where indicated or scheduled.

1.4 REGULATORY REQUIREMENTS

- A. Installation of insulation may only commence if insulation meets mandatory manufacturer certification to the California Energy Commission required by Title 24, Part 6, Section 110.8 of the CBC - California Building Code, (CCR) California Code of Regulations that insulation complies with Title 24, Part 12, Chapter 12-13, Article 3 of the California Quality Standards for Insulating Materials.
- B. Insulation products shall comply with the requirements of the California Department of Public Health's "Standard Method for the Testing and Evaluation of Volatile Organic Chemical Emissions from Indoor Sources Using Environmental Chambers."
- C. Insulation materials to be certified in compliance with Business and Professions Code Section 19165.
- D. Insulation manufacturer to be licensed by the California Department of Consumer Affairs, Bureau of Home Furnishing and Thermal Insulation according to Business and Professions Code, Section 19059.7.

1.5 SUBMITTALS

A. Submit manufacturer's certificates under provisions of Section 01 33 00 that materials meet or exceed specified regulatory requirements.

2. PART 2 PRODUCTS

2.1 MANUFACTURERS - INSULATION MATERIALS

- A. Certain Teed Corp., www.certainteed.com.
- B. Johns Manville Corp., www.jm.com.
- C. Knauf Insulation, www.knaufinsulation.us.
- D. Owens-Corning Fiberglass Corporation, www.owenscorning.com.

WLC/1719900

BLANKET INSULATION 07 21 16

E. Substitutions: Under provisions of Section 01 25 13.

2.2 MATERIALS

- A. Thermal Batt Insulation, Concealed Wall and Roof: ASTM C665 Preformed fiber glass batt, Type II Kraft Faced, Class C, Category 1 "SmartBatt", with stapling flange for attachment to applicable construction. Equivalent continuous roll membrane facing of "MemBrain" Continuous Air Barrier and Smart Vapor Retarder may be utilized in lieu of individual glass fiber batts. Provide R30 at roofs.
- B. Insulation to be formaldehyde-free.
- Nails or Staples: Steel wire; electroplated; type and size to suit application.
- D. Tape: Bright aluminum self-adhering type, mesh reinforced, 2 inch wide.
- E. Support Wire: 16 gauge steel wire.
- F. Support Rods: 13 gauge, pointed spring steel length as required for stud spacing.

3. PART 3 EXECUTION

3.1 EXAMINATION

- A. Verify that substrate, adjacent materials, and insulation are dry and ready to receive insulation.
- Verify that enclosed spaces are ventilated to dissipate humidity.
- C. Maximum relative humidity level of less than 50 percent shall be maintained during installation of insulation.

3.2 INSTALLATION

- A. Install insulation in accordance with insulation manufacturer's instructions and ASTM C1320.
- B. Install batt insulation in exterior roof spaces without gaps or voids.
- C. Fill any small spaces around door frames, window frames, skylight frames, and other wall or roof openings with insulation.
- D. Fill hollow space of steel door frame, steel window frame and other wall or roof frame with insulation.
- E. Fill hollow space created by wall or roof framed headers and jamb spaces with insulation.
- F. Install batt sound insulation in interior walls full height of wall.
- G. Install batt sound insulation above ceilings in areas as indicated. Extend a minimum of 4'-0" beyond face of vertical dividing partitions of space to be insulated where partition terminates at ceiling.
- H. Install batt sound insulation at underside of floor decking between adjacent floor levels.
- Trim insulation neatly to fit spaces.
- J. Fit insulation tight in spaces and tight to exterior side of mechanical and electrical services within the plane of insulation. Leave no gaps or voids.
- K. Install with factory applied membrane facing warm side of building spaces.
- L. Lap ends and side flanges of vapor barrier membrane over face of framing members.
- M. Extend vapor barrier on to any adjacent construction and tape seal edge of vapor barrier.
- N. Seal butt ends, lapped flanges, and tears or cuts in membrane with tape or another layer of membrane.

- O. Seal joints in vapor barrier caused by pipes, conduits, electrical boxes, and similar items penetrating vapor barrier.
- P. Face staple flange over flange of adjacent blanket to wood studs at maximum 6 inches oc.
- Q. Friction fit sound insulation between studs and fill as required to completely fill space between the wall finishes.
- R. Where wall finish does not occur, use support rods spaced not-to-exceed 16 inches oc vertically at wood studs.
- S. Retain unsupported roof insulation to metal or concrete substrate with spindle fasteners at 24 inches on center.

END OF SECTION

SECTION 12 24 00

WINDOW SHADES CLUTCH XD OPERATED WINDOW SHADES

PART 1 GENERAL

1.1 SECTION INCLUDES

A. Manually operated, roll-up fabric interior window shades including mounting and operating hardware.

1.2 RELATED SECTIONS

A. Section 09 51 23 - Acoustical Tile Ceilings.

1.3 REFERENCES

- A. NFPA 701-99 Fire Tests for Flame-Resistant Textiles and Films.
- B. GREENGUARD Environmental Institute Gold.
- C. US Green Building Council.

1.4 SUBMITTALS

- A. Submit under provisions of Section 01 33 00.
- B. Product Data: Manufacturer's data sheets on each product specified, including:
 - 1. Preparation instructions and recommendations.
 - 2. Installation and maintenance instructions.
 - 3. Styles, material descriptions, dimensions of individual components, profiles, features, finishes and operating instructions.
 - 4. Storage and handling requirements and recommendations.
 - 5. Mounting details and installation methods.
- C. Shop Drawings: Plans, elevations, sections, product details, installation details, operational clearances, and relationship to adjacent work.
- D. Window Treatment Schedule: For all roller shades. Use same room designations as indicated on the Drawings, field verified window dimensions, quantities, type of shade, controls, fabric, and color, and include opening sizes and key to typical mounting details.
- E. Selection Samples: For each finish product specified, two complete sets of shade cloth options and aluminum finish color samples representing manufacturer's full range of available colors and patterns.
- F. Verification Samples: For each finish product specified, two complete sets of shade components, unassembled, demonstrating compliance with specified requirements. Shade fabric sample and aluminum finish sample as selected, representing actual product, color, and patterns. Mark face of material to indicate interior faces.
- G. Maintenance Data: Methods for maintaining roller shades, precautions regarding cleaning materials and methods, instructions for operating hardware.
- H. Manufacturer's Certificates: Certify products meet or exceed specified requirements.

1.5 QUALITY ASSURANCE

- A. Manufacturer Qualifications: Obtain roller shades through one source from a single manufacturer with a minimum of twenty years experience in manufacturing products comparable to those specified in this section.
- B. NFPA Flame-Test: Passes NFPA 701. Materials tested shall be identical to products proposed for use.
- C. Mock-Up: Provide a mock-up of one of each type roller shade assembly specified for evaluation of mounting, appearance and accessories.
 - 1. Locate mock-up in window(s) designated by Architect.
 - 2. Do not proceed with remaining work until mock-up is accepted by Architect.

1.6 DELIVERY, STORAGE, AND HANDLING

- A. Do not deliver window shades until building is enclosed and construction within spaces where shades will be installed is substantially complete.
- B. Deliver products in manufacturer's original, unopened, undamaged containers with labels intact.
- C. Label containers and shades according to Window Shade Schedule.
- D. Store products in manufacturer's unopened packaging until ready for installation.

1.7 SEQUENCING

- A. Ensure that locating templates and other information required for installation of products of this section are furnished to affected trades in time to prevent interruption of construction progress.
- B. Ensure that products of this section are supplied to affected trades in time to prevent interruption of construction progress.

1.8 PROJECT CONDITIONS

A. Install roller shades after finish work and ambient temperature, humidity and ventilation conditions are maintained at levels recommended for project upon completion.

1.9 WARRANTY

A. Hardware and Shade Fabric: Draper's standard twenty-five year limited warranty.

1.10 MANUFACTURERS

- A. Acceptable Manufacturer: Draper, Inc., which is located at: 411 S. Pearl P. O. Box 425; Spiceland, IN 47385-0425. ASD. Toll Free Tel: 800-238-7999; Tel: 765-987-7999; Fax: 866-637-5611; Web:www.draperinc.com.
- B. Substitutions: As equal.
- C. Requests for substitutions will be considered in accordance with provisions of Section 01 25 13.

1.11 MANUALLY OPERATED WINDOW SHADES

A. Manually Operated Window Shades with Independent Control: Manually operated, vertical roll-up, fabric window shade with components necessary for complete installation; Manual

FlexShade XD as manufactured by Draper, Inc.

- 1. Operation: Bead chain and clutch operating mechanism allowing shade to stop when chain is released. Designed never to need adjustment or lubrication. Provide limit stops to prevent shade from being raised or lowered too far.
 - a. Clutch mechanism: Fabricated from POM thermoplastic with welded 0.354 inch (9 mm) primary steel post with rotational bearing, overrunning design, and positive mechanical engagement of drive mechanism to tube. White or Black color as selected by Architect. Center bead chain placement for right or left hand operation and accommodates side channel with no adjustment of chain location.
 - b. Bead chain loop: Stainless steel bead chain.
 - c. Bead chain loop: Polyester bead chain, Ivory, Grey, White, Bronze or Black color as selected by Architect.
 - d. Bead Chain Hold Down: P-Clip.
 - e. Bead Chain Hold Down: Spring-Loaded Tensioner.
- 2. Rollers: Extruded aluminum roller tube of appropriate diameter to support shade fabric with minimal deflection.
 - a. Minimum Roller Tube Diameter: 1.56 inches.
 - b. Fabric Connection to Roller Tube: Spline fabric/roller attachment system to allow shade fabric to be removed from roller without having to remove roller from brackets.
 - c. Fabric Length: 6 inches greater than window height minimum.
 - Bottom Slat: 13/16 inch aluminum dowel, encased in bottom hem with heat sealed ends.
 - e. Orientation: Regular from back of roller.
 - f. Orientation: Reverse from front of roller.

3. Bottom Slat

- a. Closed pocket elliptical slat: 1" aluminum elliptical slat inside of a 1 5/8" pocket with heat sealed ends
- Open pocket elliptical slat: 1" aluminum elliptical slat with plastic ends inside of a 1 5/8" pocket.
- c. Flat exposed hem bar: Small: 7/8" x 5/16" and Large 1½" x 5/16" aluminum rectangular hem bar with plastic end caps. Powder coated in black, bronze, ivory, white or clear anodized.
- d. Round exposed hem bar: Small 5/8" and Large 13/16" aluminum with plastic end caps. Powder coated in black, bronze, ivory, white or clear anodized.

4. Mounting:

- a. Endcaps only.
- b. Endcaps and fascia.
- c. Endcaps and headbox.
- d. Headbox.
- e. Ceiling pocket.
- f. Dual roller endcaps only.
- g. Dual roller fascia.
- h. Dual roller horizontal fascia.
- i. Dual roller with pocket headbox.
- 5. Endcaps: Stamped steel with universal design suitable for mounting to ceiling, wall, and jamb. Provide size compatible with roller size.
 - a. Endcap covers: To match fascia or headbox color.
 - b. Mounted to ceiling.
 - c. Mounted to wall.
 - d. Mounted to jamb.
- 6. Fascia: L shaped aluminum extrusion to conceal shade roller and hardware.
 - Attachment: Snaps onto endcaps without requiring exposed fasteners of any kind. Fascia can be mounted continuously across two or more shade bands. No notching is required.

- b. Shape: Square Fascia Panel.
- c. Shape: Dual Roller Fascia Panel.
- d. Shape: Dual Roller Horizontal Fascia Panel.
- e. Finish: Clear anodized.
- f. Finish: Black powder coat.
- g. Finish: White powder coat.
- h. Finish: Ivory powder coat.
- i. Finish: Bronze powder coat.
- j. Finish: Custom powder coat as selected by the Architect.
- 7. Headbox Ceiling/Wall style: Aluminum fabrication with removable closure, endcaps, and back and top cover piece:
 - a. Finish: Clear anodized.
 - b. Finish: Black powder coat.
 - c. Finish: White powder coat.
 - d. Finish: Ivory powder coat.
 - e. Finish: Bronze powder coat.
 - f. Finish: Custom powder coat as selected by the Architect.
- 8. Light Gap Reduction Channels.
 - a. L Angle 3/4 inch by 1 inch.
 - b. L Angle -1 inch by 2-3/4 inches.
 - c. U Channel -1 inch by 2-1/2 inches.
 - d. H Channel 1 inch by 5 inches.

1.12 FABRIC

- A. Light-Filtering Fabrics
 - SheerWeave Series SW2703: Duplex basketweave fabric-light exterior color combined with dark interior color for thermal comfort and view-through. GREENGUARD Children & Schools, and Gold certified as a low emitting fabric. Manufacturer to supply GREENGUARD Children & Schools, and Gold certificate. Fire rating: NFPA 701. SW2703-3 percent open.
- B. Color and pattern: SW2703-P28 3% Oyster/Charcocal.

PART 2 EXECUTION

2.1 EXAMINATION

- A. Do not begin installation until substrates have been properly prepared.
- B. If substrate preparation is the responsibility of another installer, notify Architect of unsatisfactory preparation before proceeding.

2.2 PREPARATION

- Coordinate requirements for blocking and structural supports to ensure adequate means for installation of window shades.
- B. Coordinate requirements for blocking, construction of shade pockets, and structural supports to ensure adequate means for installation of window shades.
- C. Coordinate installation of recessed shade pockets with construction of suspended acoustical panel ceilings specified in Section 09 51 23.

2.3 INSTALLATION

A. Install in accordance with manufacturer's instructions.

- B. Install roller shades level, plumb, square, and true. Allow proper clearances for window operation hardware.
- C. Shade pockets:
 - Install shade pockets prior to installation of suspended ceiling system. Attach to supporting structure with screws through top of pocket at 24 inches (610 mm) minimum centers.
 - 2. Install shade pockets in conjunction with installation of suspended ceiling system. Attach to supporting structure with screws through top of pocket at 24 inches (610 mm) minimum centers.
 - 3. Install corner pieces securely and in alignment with pockets.
 - 4. Install pocket ends securely and in alignment with pockets.
 - 5. After interior construction is essentially complete, install shade and operating mechanism in pocket.
- D. Install the following items to conceal roller and operating mechanism. Do not use exposed fasteners.
 - 1. Fascias.
 - 2. Closure panels.
 - 3. Endcaps.
- E. Install headbox, side channels, and sill channel with sealant specified in Section 07 92 00 -Joint Sealants.
- F. Position shades level, plumb, and at proper height relative to adjacent construction. Secure with fasteners recommended by manufacturer.

2.4 TESTING AND DEMONSTRATION

- A. Test window shades to verify that interface to other building systems and other operating components are functional. Correct deficiencies.
- B. Test window shades to verify that operating mechanism, fabric retainer, and other operating components are functional. Correct deficiencies.
 - 1. Chain and clutch.
- C. During daylight hours, lower shades and turn off interior lights. Verify that there are no light leaks at perimeter or within shade assembly. Correct deficiencies.
- D. Demonstrate operation of shades to Owner's designated representatives.


2.5 PROTECTION


- A. Protect installed products until completion of project.
- B. Touch-up, repair or replace damaged products before Substantial Completion.

2.6 SCHEDULES

A. Refer to Drawings for shade types and locations.

END OF SECTION

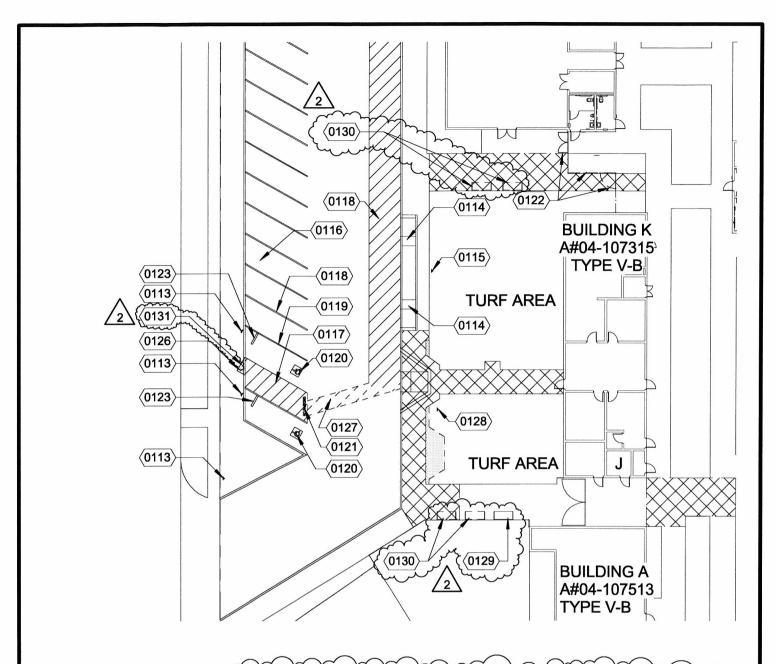

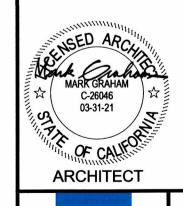

$\frac{1}{2}$	KEYNOT	DESCRIPTION
_}		
>	0129	(E) 6'-0" SURFACE MOUNTED BENCH TO REMAIN AND PROTECT IN PLACE
7	0130	REMOVE (E) 6'-0" SURFACE MOUNTED BENCH FOR REINSTALLATION
7	0131	REMOVE (E) SPRINKLER HEAD FOR RELOCATION
7	M M	~~ ~ ~ ~ ~ ~ ~ ~ ~ ~ ~ ~ ~ ~ ~ ~ ~ ~ ~

APPL. 04-117697

REF. DRAWING NO: A1.1

ARCHITECTS WLC

RANCHO CUCAMONGA

CALIFORNIA 91730

8163 ROCHESTER AVE. SUITE 100

COLE ELEMENTARY SCHOOL MODERNIZATION


SAN BERNARDINO CITY UNIFIED SCHOOL DISTRICT


1331 N. COLE AVE, HIGHLAND, CA 92346


DEMOLITION SITE PLAN

DRWN:	JY
CHKD:	CTW
DATE:	8/28/2019
SCALE:	1" = 30'-0"
JOB NO:	1719900

ADD-02

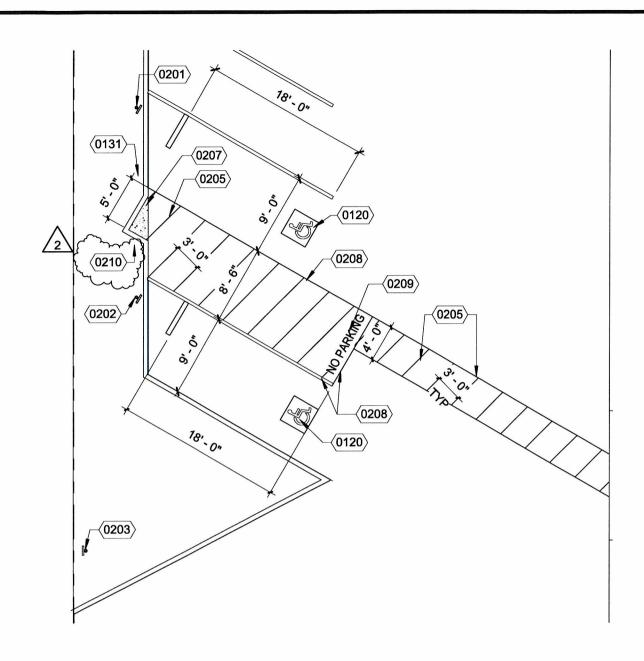

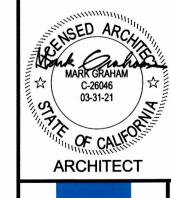

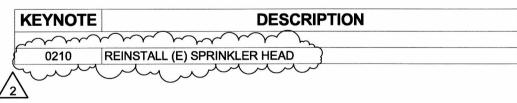

ARCHITECT

APPL. 04-117697

2/ A1.2 **REF. DRAWING NO:**



SUITE 100

RANCHO CUCAMONGA

CALIFORNIA 91730


COLE ELEMENTARY SCHOOL MODERNIZATION

SAN BERNARDINO CITY **UNIFIED SCHOOL DISTRICT**

> 1331 N. COLE AVE, HIGHLAND, CA 92346

DRWN:	JY
CHKD:	CTW
DATE:	8/28/2019
SCALE:	1" = 10'-0"
JOB NO:	1719900

ADD-02 A02

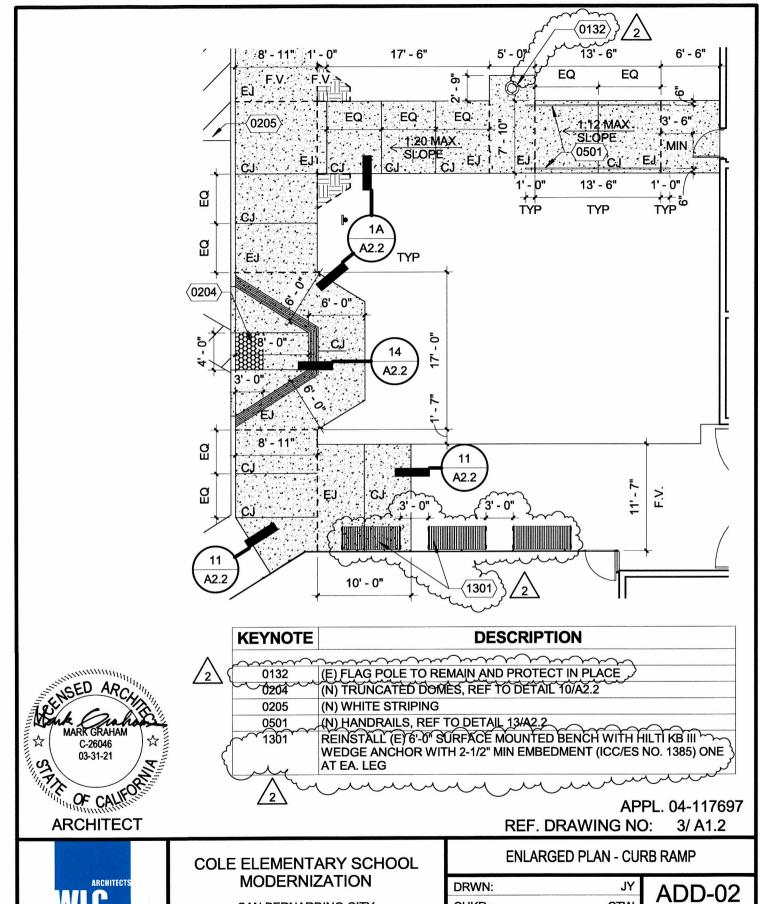


8163 ROCHESTER AVE.
SUITE 100
RANCHO CUCAMONGA
CALIFORNIA 91730

SAN BERNARDINO CITY UNIFIED SCHOOL DISTRICT


1331 N. COLE AVE, HIGHLAND, CA 92346

DRWN:	JY
CHKD:	CTW
DATE:	8/28/2019
SCALE:	1" = 10'-0"
JOB NO:	1719900

ADD-02 **A**03

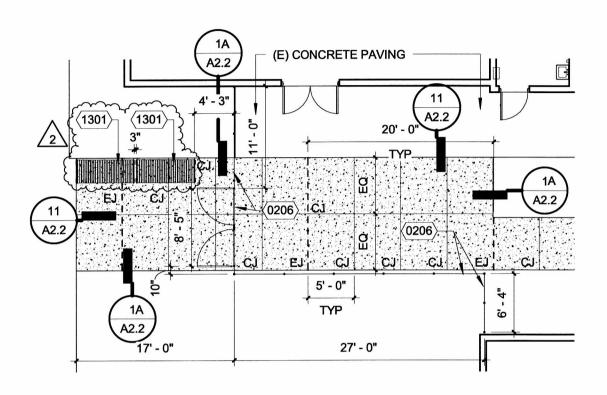



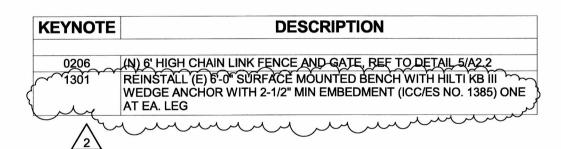

ARCHITECT

APPL. 04-117697

4A/A1.2 **REF. DRAWING NO:**

ARCHITECTS

8163 ROCHESTER AVE. SUITE 100 RANCHO CUCAMONGA CALIFORNIA 91730

COLE ELEMENTARY SCHOOL MODERNIZATION


SAN BERNARDINO CITY UNIFIED SCHOOL DISTRICT

> 1331 N. COLE AVE, HIGHLAND, CA 92346

ENLARGED PLAN - FENCES

DRWN:	JY
CHKD:	CTW
DATE:	8/28/2019
SCALE:	1" = 10'-0"
JOB NO:	1719900

ADD-02

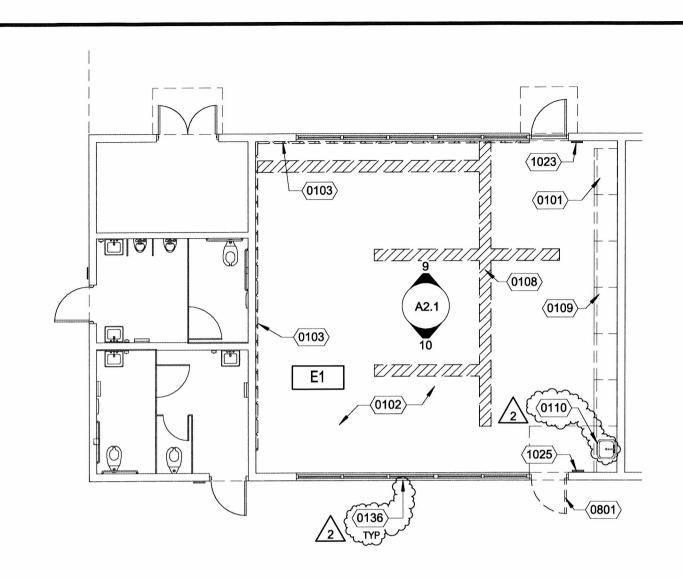

	$\sim\sim\sim$	man
KEYNOTE		DESCRIPTION
Λ		
/2	0110	REMOVE (E) CASEWORK WITH SINK AND EXPOSED PIPING, CAP ALL PIPES ON THE WALL OR FLOOR
(0136	REMOVE (E) WINDOW MTL SCREEN
(



APPL. 04-117697

REF. DRAWING NO: 1/A2.1



RANCHO CUCAMONGA

CALIFORNIA 91730

COLE ELEMENTARY SCHOOL MODERNIZATION


SAN BERNARDINO CITY UNIFIED SCHOOL DISTRICT

1331 N. COLE AVE, HIGHLAND, CA 92346


BUILDING E ENLARGED DEMO FLOOR PLAN

DRWN:	JY
CHKD:	CTW
DATE:	8/28/2019
SCALE:	1/8" = 1'-0"
JOB NO:	1719900

ADD-02

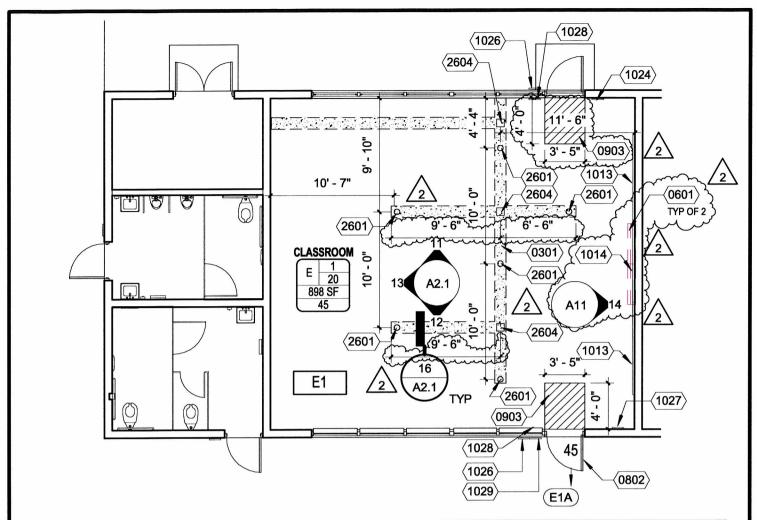

KEYNOTE	DESCRIPTION
Λ	
2 0301	(N) CONCRETE SLAB, REF TO DETAIL 16/A2.1
(0601	(N) LAMINATE SHELVES, REF TO DRAWING A14 \
0802	(N) DOORWITH HARDWARE, REFTO DOOR SCHEDULE AND SPEC
A 0903	(N) WALK OFF MAT TANDUS CENTIVA - GEO TILE #00979
2 1013	(N) 8'W X 4'H MARKERBOARD, REF TO SPEC, 4" MAX PROJECTION (N) 86" ACTIVPANEL WITH MOUNTING BRACKET, REFER TO ATTACHED
(1014	(N) 86" ACTIVPANEL WITH MOUNTING BRACKET, REFER TO ATTACHED
ξ	DRAWING A12 FOR BACKING
1024	REINSTALL (E) NON-ACCESSIBLE SIGN AT THE SAME LOCATION
1026	(N) ROOM ID SIGN, REF TO DETAIL 18/A2.2
1027	(N) ASSISTIVE LISTENING SIGN, REF TO DETAIL 19/A2.2
1028	(N) EXIT SIGN, REF TO DETAIL 22/A2.2
1029	(N) ACCESSIBLE ENTRY SIGN, REF TO DETAIL 23/A2.2

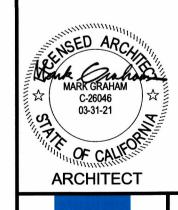

APPL. 04-117697

ADD-02

A06

REF. DRAWING NO: 2/ A2.1

BUILDING E ENLARGED NEW FLOOR PLAN




SAN BERNARDINO CITY UNIFIED SCHOOL DISTRICT

1331 N. COLE AVE, HIGHLAND, CA 92346

DRWN:	JY
CHKD:	CTW
DATE:	8/28/2019
SCALE:	1/8" = 1'-0"
JOB NO:	1719900

8163 ROCHESTER AVE.
SUITE 100
RANCHO CUCAMONGA
CALIFORNIA 91730

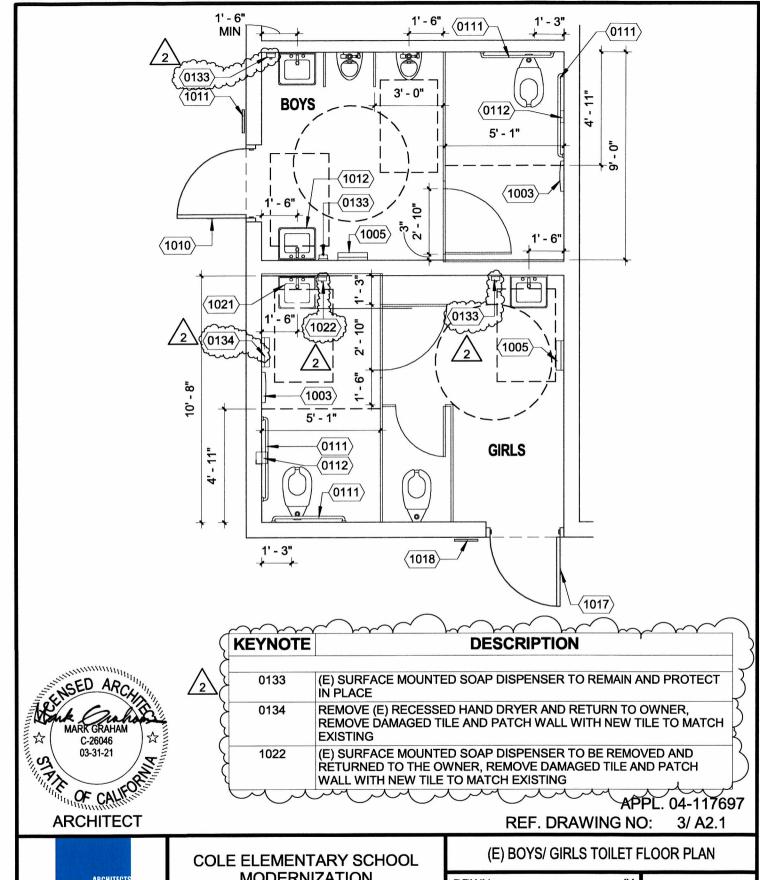




MODERNIZATION


SAN BERNARDINO CITY UNIFIED SCHOOL DISTRICT

> 1331 N. COLE AVE, HIGHLAND, CA 92346

DRWN:	JY
CHKD:	CTW
DATE:	8/28/2019
SCALE:	1/4" = 1'-0"
JOB NO:	1719900

ADD-02

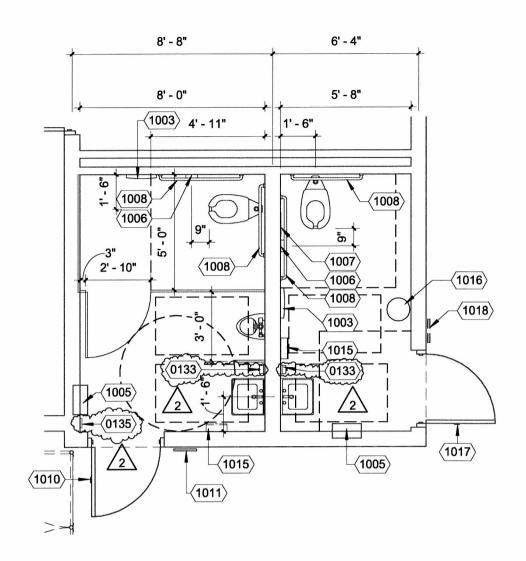

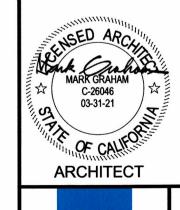

	KEYNOTE	DESCRIPTION
$\frac{1}{2}$	0133	(E) SURFACE MOUNTED SOAP DISPENSER TO REMAIN AND PROTECT IN PLACE
{	0135	REMOVE (E) LIGHTING SWITCH FOR RELOCATION, COVER THE EXISTING OUTLET BOX WITH METAL COVER AND PATCH WALL TILE TO MATCH EXISTING
	1006	(É) RECESSED TOILET TISSUE DISPNESER TO REMAIN
	1007	(E) RECESSED SANITARY NAPKIN DISPOSAL TO REMAIN
	1008	(E) GRAB BAR TO REMAIN

APPL, 04-117697

REF. DRAWING NO: 5/ A2.1



SUITE 100

RANCHO CUCAMONGA

CALIFORNIA 91730

COLE ELEMENTARY SCHOOL MODERNIZATION


SAN BERNARDINO CITY UNIFIED SCHOOL DISTRICT

> 1331 N. COLE AVE, HIGHLAND, CA 92346


(E) MEN.WOMEN	TOILET	FLOOF	R PLAN
---------------	--------	-------	--------

DRWN:	JY
CHKD:	CTW
DATE:	8/28/2019
SCALE:	1/4" = 1'-0"
JOB NO:	1719900

ADD-02

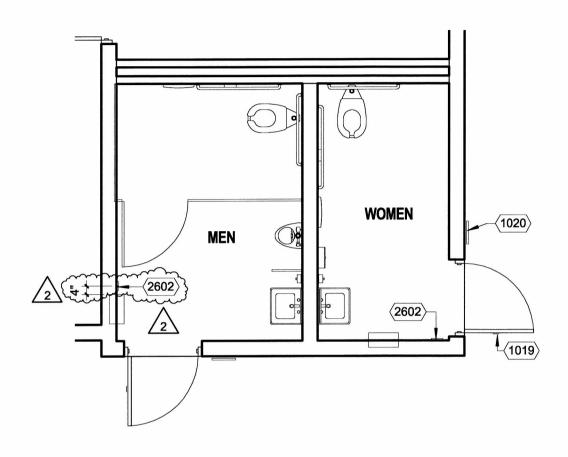



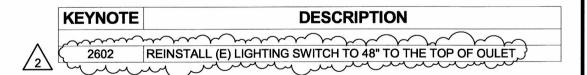

ARCHITECT

APPL. 04-117697

REF. DRAWING NO: 6/ A2.1



SUITE 100

RANCHO CUCAMONGA

CALIFORNIA 91730

COLE ELEMENTARY SCHOOL MODERNIZATION


SAN BERNARDINO CITY UNIFIED SCHOOL DISTRICT

> 1331 N. COLE AVE, HIGHLAND, CA 92346

(N) MEN/WOMEN TOILET FLOOR PLAN

DRWN:	JY
CHKD:	CTW
DATE:	8/28/2019
SCALE:	1/4" = 1'-0"
JOB NO:	1719900

ADD-02

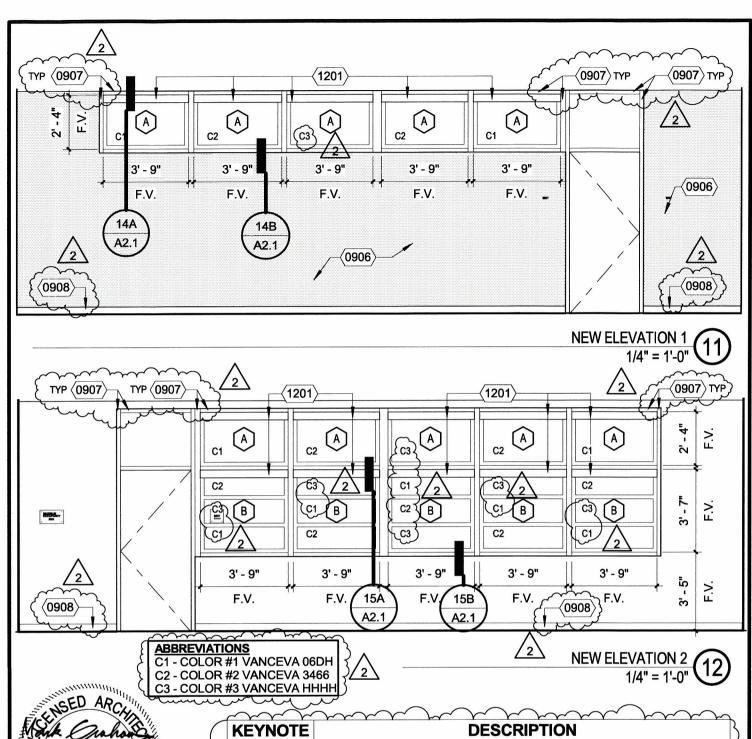



0906 (N) TACKBOARD, REF TO SPEC, COLOR SAPPHIRE M621-77 0907 PAINT (E) INT. & EXT. WOOD TRIMS, COLOR SELECT BY ARCHITECT (N) 4" RUBBER BASE, COLOR SELECT BY ARCHITECT 0908

ARCHITECT

ARCHITECTS

APPL: 04-117697 REF. DRAWING NO: 11 & 12/A2.1

NEW ELEVATION 1 & 2

COLE ELEMENTARY SCHOOL MODERNIZATION


SAN BERNARDINO CITY UNIFIED SCHOOL DISTRICT


> 1331 N. COLE AVE, HIGHLAND, CA 92346


DRWN:	JY
CHKD:	CTW
DATE:	8/28/2019
SCALE:	1/4" = 1'-0"
JOB NO:	1719900

ADD-02 A10

8163 ROCHESTER AVE. SUITE 100 RANCHO CUCAMONGA **CALIFORNIA 91730**

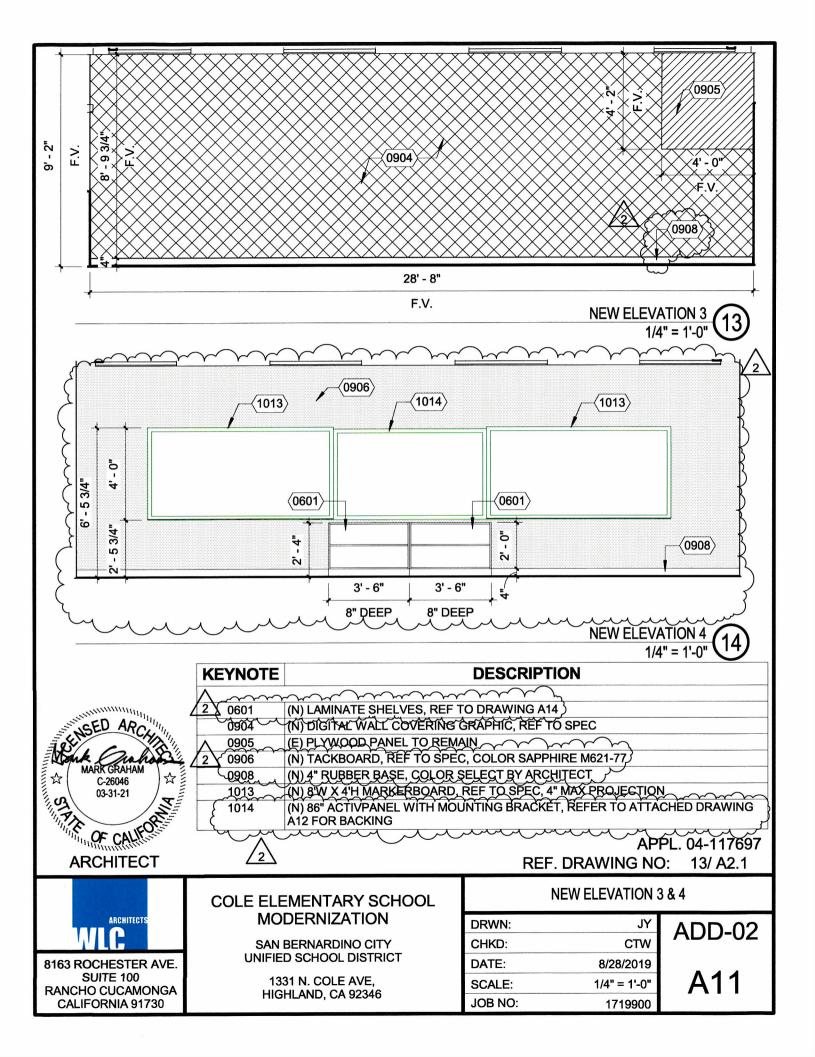

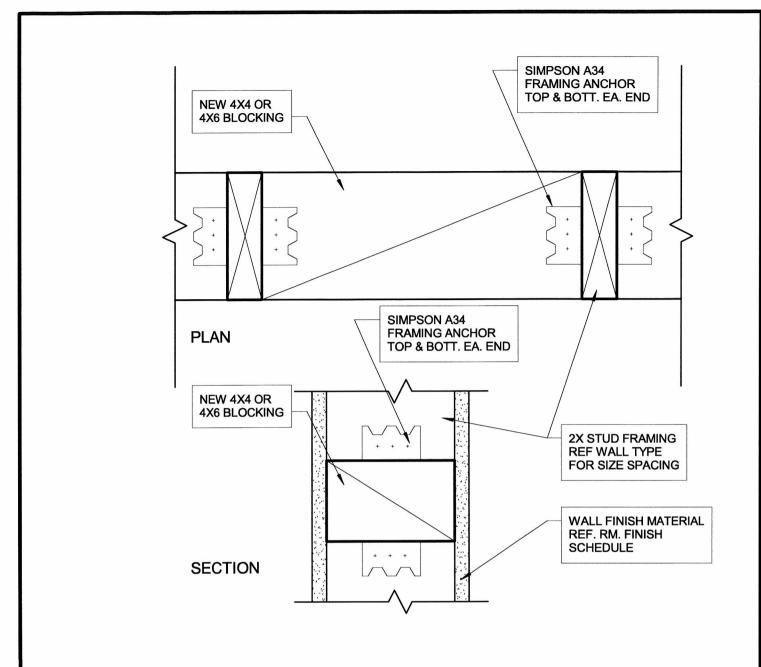

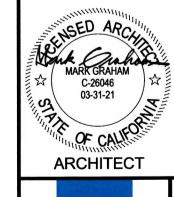

ARCHITECT

APPL. 04-117697

REF. DRAWING NO:



RANCHO CUCAMONGA

CALIFORNIA 91730

COLE ELEMENTARY SCHOOL MODERNIZATION


SAN BERNARDINO CITY UNIFIED SCHOOL DISTRICT


> 1331 N. COLE AVE, HIGHLAND, CA 92346

TYP	WOOD	BACKING	DETAIL

DRWN:	CTW
CHKD:	CTW
DATE:	8/28/2019
SCALE:	3" = 1'-0"
JOB NO:	1719900

ADD-02

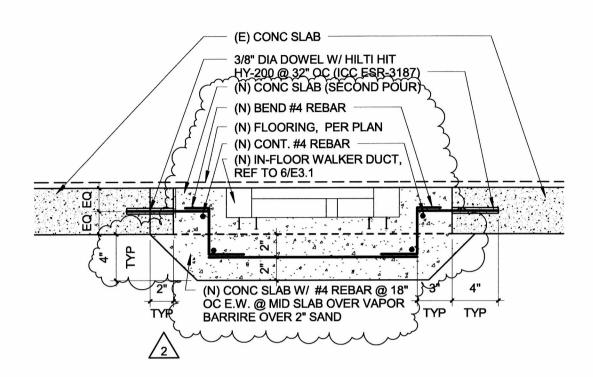

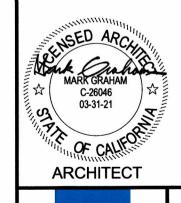

APPL. 04-117697

REF. DRAWING NO: 16/A2.1



RANCHO CUCAMONGA

CALIFORNIA 91730

COLE ELEMENTARY SCHOOL MODERNIZATION

SAN BERNARDINO CITY UNIFIED SCHOOL DISTRICT

1331 N. COLE AVE, HIGHLAND, CA 92346


DRWN:	CTW
CHKD:	CTW
DATE:	8/28/2019
SCALE:	1 1/2" = 1'-0"
JOB NO:	1719900


ADD-02


A B C CASEWORK ANCHORAGE LOCATIONS

ANCHORAGE NOTES:

- 1. CASEWORK (FRONT) (BACK) (TOP) (BOTTOM)
- 2. FACE OF WALL
- 3. 1 x 4 CONT WOOD CLEAT
- WOOD STUD FRAMING #14 FHWS W/ 2-1/2" MIN PENETRATION INTO 3X6 WD BLKG. 3" MAX FROM EA END. ANC BLKG TO EA WALL STUD W/ A34 ANC T& B. PROVIDE 5 EA. ON TOP, MIDDLE AND BOTTOM ROW.
- 3/4" PARTICLE BOARD BASE
- 6. CONT 2-1/2" X 2-1/2" X 0.0538" THK GALV BENT SHT MET ANGLE
- 7. #12 x 1-1/2" LONG FHWS 3" FROM EA END AND @ 12" OC
- 3/8" DIA SIMPSON STRONG BOLT 2 W/ 2" MIN EMBEDDMENT, 3" FROM EA END & AT 16" OC W/ 6" MIN EDGED DISTANCE. ICC/ES NO. 3037, MINIMUM 2 PER CABINET.

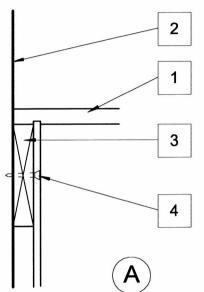

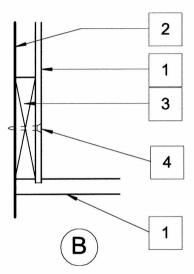

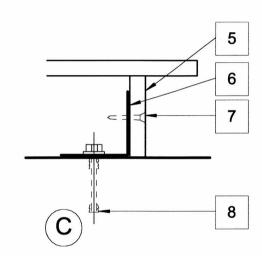

LAMINATED PLASTIC CASEWORK MATERIALS

FABRICATE IN ACCORDANCE WITH SECTION 10 OF NORTH AMERICAN ARCHITECTURAL WOODWORK STANDARDS:

- 1. CORE MATERIAL: MEDIUM DENSITY FIBERBOARD.
- 2. CONSTURCTION: STYLE FRAMELESS.
- 3. JOINERY: DOWELED JOINTS.
- 4. CABINET BACKS: BLIND DADOED.
- 5. BASE: MOISTURE RESISTANT.
- 6. SHELVES: 1-M-2 PARTICLE BOARD, WITH HPDL TWO SIDES 1 INCH THICK, MOE OF 710,000, CAPABLE OF SUPPORTING 50LB/SQ FT LOAD WITH DEFLECTION OF L/144.
- 7. SHELF EDGE BANDS: 0.028 INCH HIGH PRESSURE PLASTIC LAMINATE IN COLOR TO MATCH SHELF. ALL 4 EDGES OF ADJUSTABLE SHELVES TO RECEIVE BANDING.
- $8.\ \mbox{EXPOSED}$ SURFACED: 0.028 INCH HIGH PRESSURE PLASTIC LAMINATE, COLOR AND PATTERN AS SELECTED BY ARCHITECT.



APPL. 04-117697 REF. DRAWING NO:

CHELVES DETAIL


COLE ELEMENTARY SCHOOL MODERNIZATION

SAN BERNARDINO CITY UNIFIED SCHOOL DISTRICT

1331 N. COLE AVE, HIGHLAND, CA 92346

STILLVES DETAIL		
DRWN:	Author	ADD-02
CHKD:	Checker	ADD-02
DATE:	8/28/2019	
SCALE:	3" = 1'-0"	A14
JOB NO:	1719900	

8163 ROCHESTER AVE. SUITE 100 RANCHO CUCAMONGA CALIFORNIA 91730

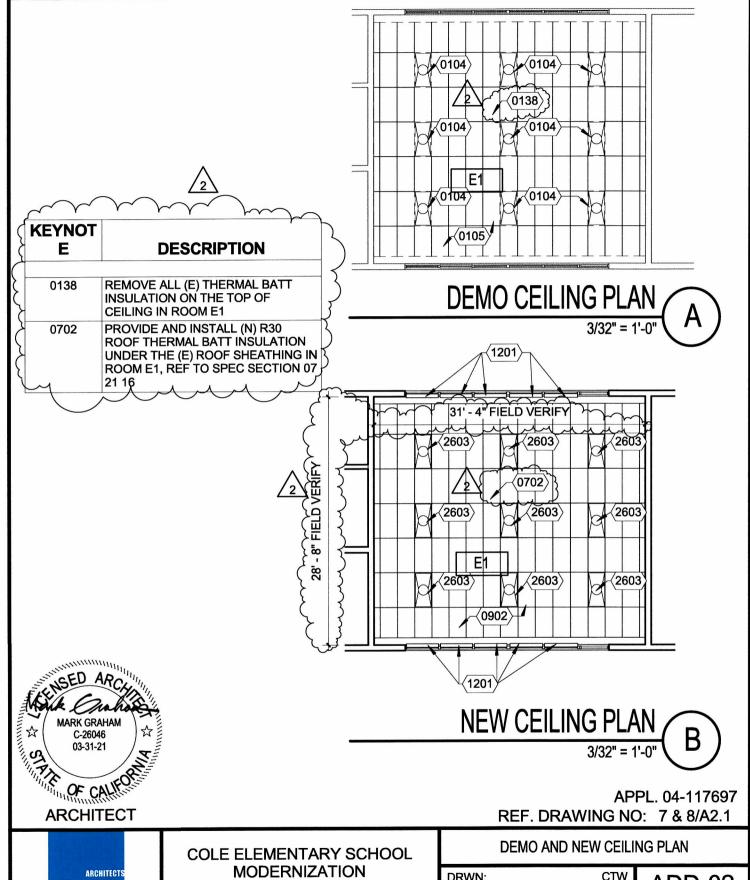


8163 ROCHESTER AVE. SUITE 100 RANCHO CUCAMONGA CALIFORNIA 91730

SAN BERNARDINO CITY UNIFIED SCHOOL DISTRICT

1331 N. COLE AVE, HIGHLAND, CA 92346

DRWN:	CTW
CHKD:	CTW
DATE:	09/09/19
SCALE:	3/32" = 1'-0"
JOB NO:	1719900


ADD-02

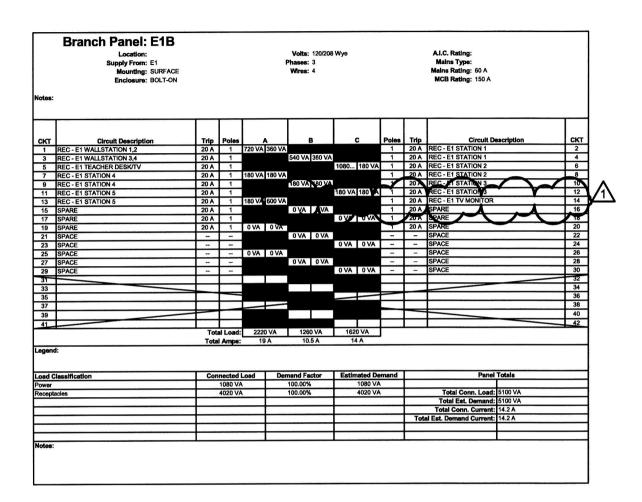





901 VIA PIEMONTE SUITE 400 ONTARIO, CA 91764 909.477.6915 FAX: 909.477.6916 www.imegcorp.com #18003005.00

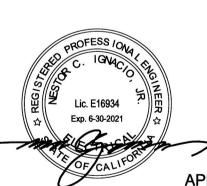

APPL. 04-117697

REF. DRAWING NO: E0.3



8163 ROCHESTER AVE. SUITE 100 RANCHO CUCAMONGA CALIFORNIA 91730

COLE ELEMENTARY SCHOOL MODERNIZATION

SAN BERNARDINO CITY UNIFIED SCHOOL DISTRICT


1331 N. COLE AVE, HIGHLAND, CA 92346

PANEL SCHEDULE SKETCH

DRWN:	JI
CHKD:	NI
DATE:	08/12/19
SCALE:	NTS
JOB NO:	1719900

ADD-02

E01

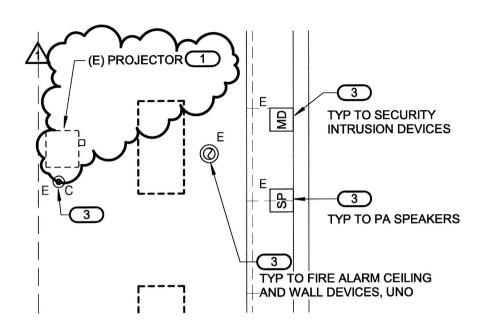





901 VIA PIEMONTE SUITE 400 ONTARIO, CA 91764 909.477.6915 FAX: 909.477.6916 www.imegcorp.com #18003005.00



APPL. 04-117697

ADD-02

E02

REF. DRAWING NO: 1/E2.1



8163 ROCHESTER AVE. SUITE 100 RANCHO CUCAMONGA CALIFORNIA 91730


COLE ELEMENTARY SCHOOL MODERNIZATION

SAN BERNARDINO CITY UNIFIED SCHOOL DISTRICT

1331 N. COLE AVE, HIGHLAND, CA 92346

DEMOLITION PLAN SKETCH

DRWN:	JI
CHKD:	NI
DATE:	08/12/19
SCALE:	1/4" = 1'-0"
JOB NO:	1719900

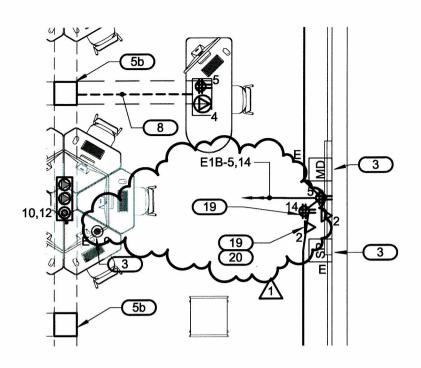

KEY NOTES

- 19. OUTLET FOR TOUCHSCREEN TV MONITOR AND IS PC MODULE. MOUNT OUTLET BEHIND TV MONITOR +60" AFF. COORDINATE EXACT LOCATION WITH TV MOUNTING HARDWARE. TV MONITOR SHALL BE EQUAL OR SIMILAR TO CLEV-15486LUXEX PLUS SERIES 4K LUX SERIES (DUAL SLOT) WITH CHIEF-XTM1U MICRO-ADJUST TILT X-LARGE WALL MOUNTING HARDWARE.
- 20. PROVIDE 1" CONDUIT TO CEILING SPACE WITH (2) CAT6a CABLES AND HOMERUN TO IDF-E. PROVIDE J-HOOKS IN CEILING SPACE FOR CABLE PATHWAY.



♦IMEG

901 VIA PIEMONTE SUITE 400 ONTARIO, CA 91764 909.477.6915 FAX: 909.477.6916 www.imegcorp.com #18003005.00



APPL. 04-117697

REF. DRAWING NO: 3/E2.1



8163 ROCHESTER AVE. SUITE 100 RANCHO CUCAMONGA CALIFORNIA 91730

COLE ELEMENTARY SCHOOL MODERNIZATION

SAN BERNARDINO CITY UNIFIED SCHOOL DISTRICT

1331 N. COLE AVE, HIGHLAND, CA 92346

POWER & SIGNAL PLAN SKETCH

DRWN:	JI
CHKD:	NI
DATE:	08/12/19
SCALE:	1/4" = 1'-0"
JOB NO:	1719900

ADD-02

E03